
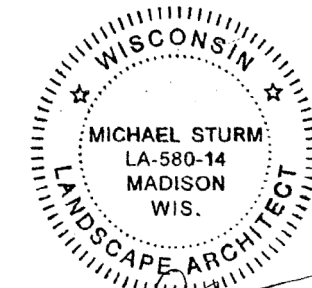


# BURR JONES PARK - SITE IMPROVEMENTS

CONTRACT 8359

MUNIS: 17395 -51 -130


BURR JONES PARK  
1820 E. WASHINGTON AVE.  
MADISON, WI 53704

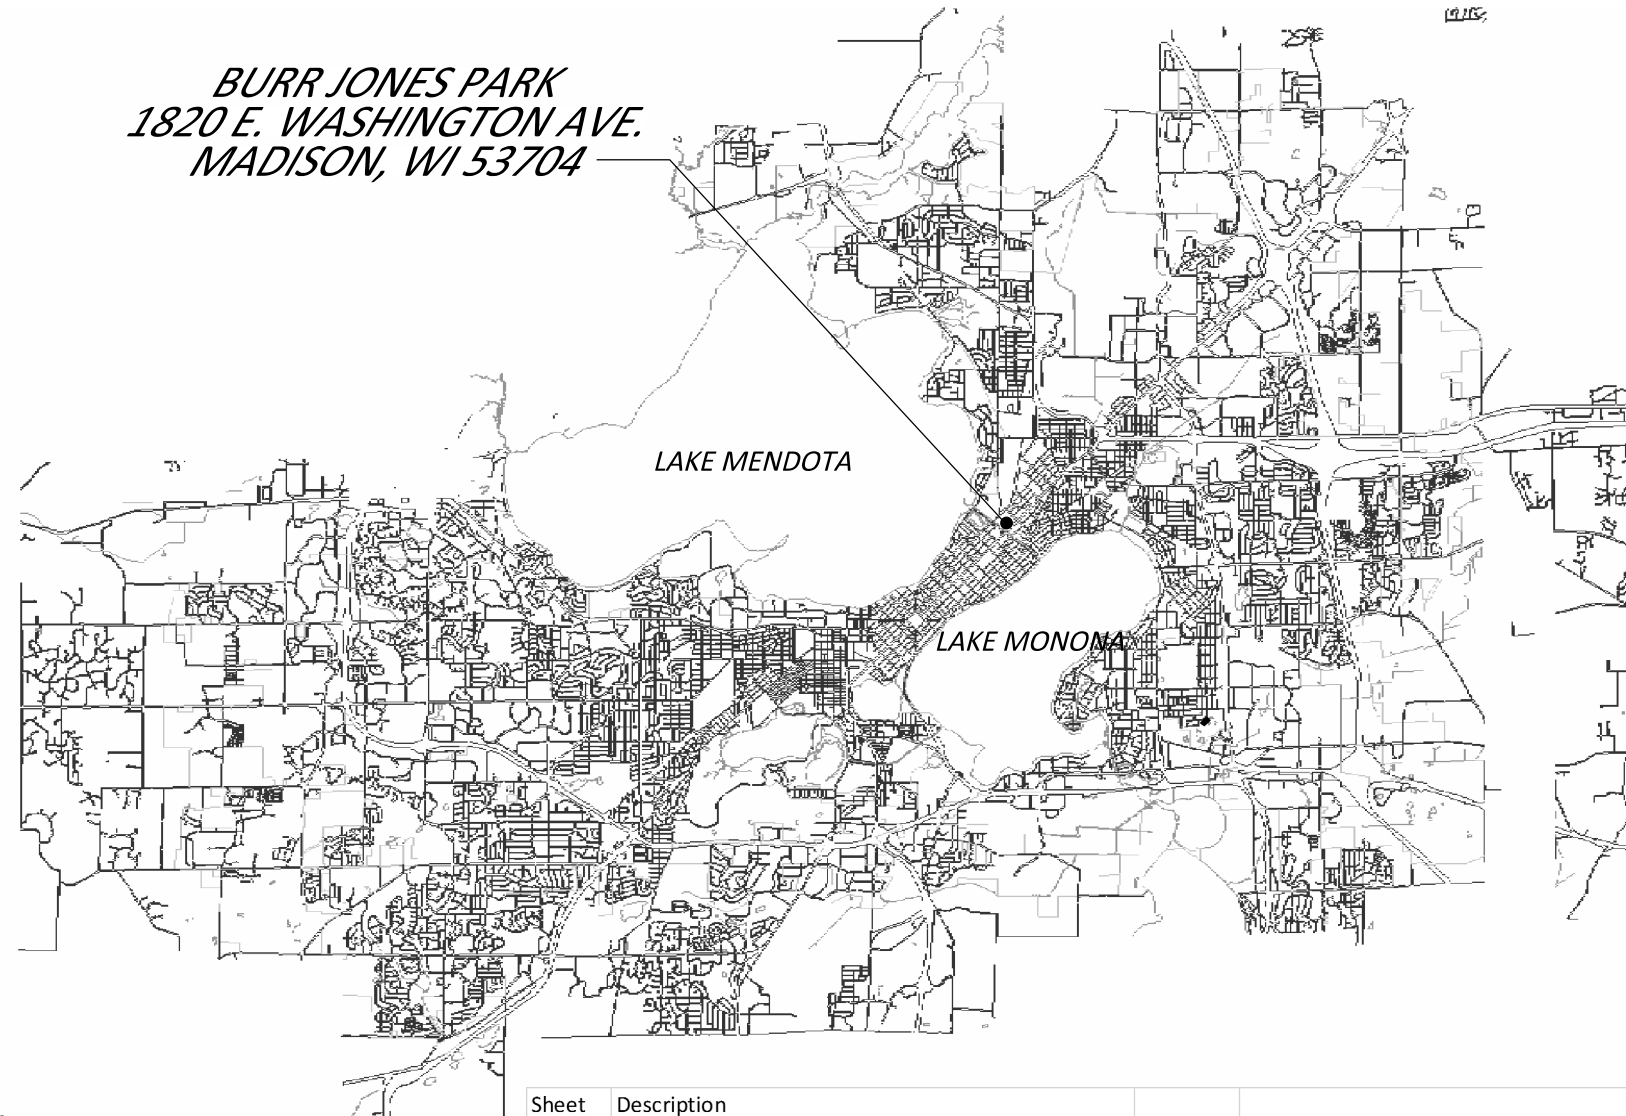

*Michael Sturm*  
05-17-19



*Michael Hein*  
5.30.19

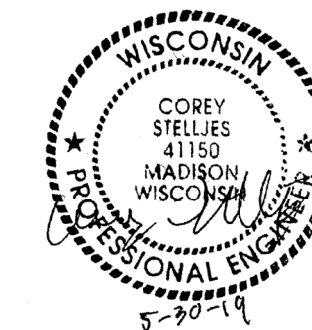

*Corey Stelljes*  
5-30-19

City of Madison  
Department of Public Works  
PARKS DIVISION

City-County Building, Suite 104  
210 Martin Luther King, Jr. Blvd.  
Madison, WI 53703

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**MADISON  
PARKS**

PROJECT:

**BURR JONES  
PARK SITE  
IMPROVEMENTS**

**BURR JONES PARK  
1820 E. WASHINGTON AVE.  
MADISON, WI 53704**

Although every effort has been made in preparing these plans and checking them for accuracy, the contractor and subcontractors must check all details and dimensions of their trade and be responsible for the same.


ITEM	DATE
Drawing by: MS	05-23-19
Advertised to bid:	05-30-19

PUBLIC WORKS PROJECT #:  
**8359**

SHEET TITLE:

SHEET NUMBER:


Sheet	Description				
1.0	Project Location Plan	6.0	Grading Plan	8.0	Site Restoration Plan
2.0	Existing Site Plan	6.1	Grading Plan - Basketball Court and Path	9.0	Utility Plan - Electrical Service
2.1	Existing Utility Easements Plan	6.2	Grading Plan - Parking Lot	9.1	Utility Plan - Electrical Service Details
3.0	Site Access, Erosion Control and Site Protection Plan	6.3	Grading Plan - Field North	10.0	Athletic Field Lighting - Pole Footings
4.0	Demolition Plan	6.4	Grading Plan - Field South	10.1	Athletic Field Lighting - Pole Schedule
5.0	Site Plan	6.5	Path Profile	10.2	Athletic Field Lighting - Photometrics
5.1	Site Plan - Basketball Court and Path	6.6	Isopach Plan (Reference Only)	11.0	Site Details - Path Section
5.2	Site Plan - Parking Lot	6.7	Grading Computations	11.1	Site Details - Basketball Goal
5.3	Site Plan - Field North	7.0	Utility Plan - Storm Sewer	11.2	Site Details - Fence
5.4	Site Plan - Field South	7.1	Bio-Retention Basin Section		

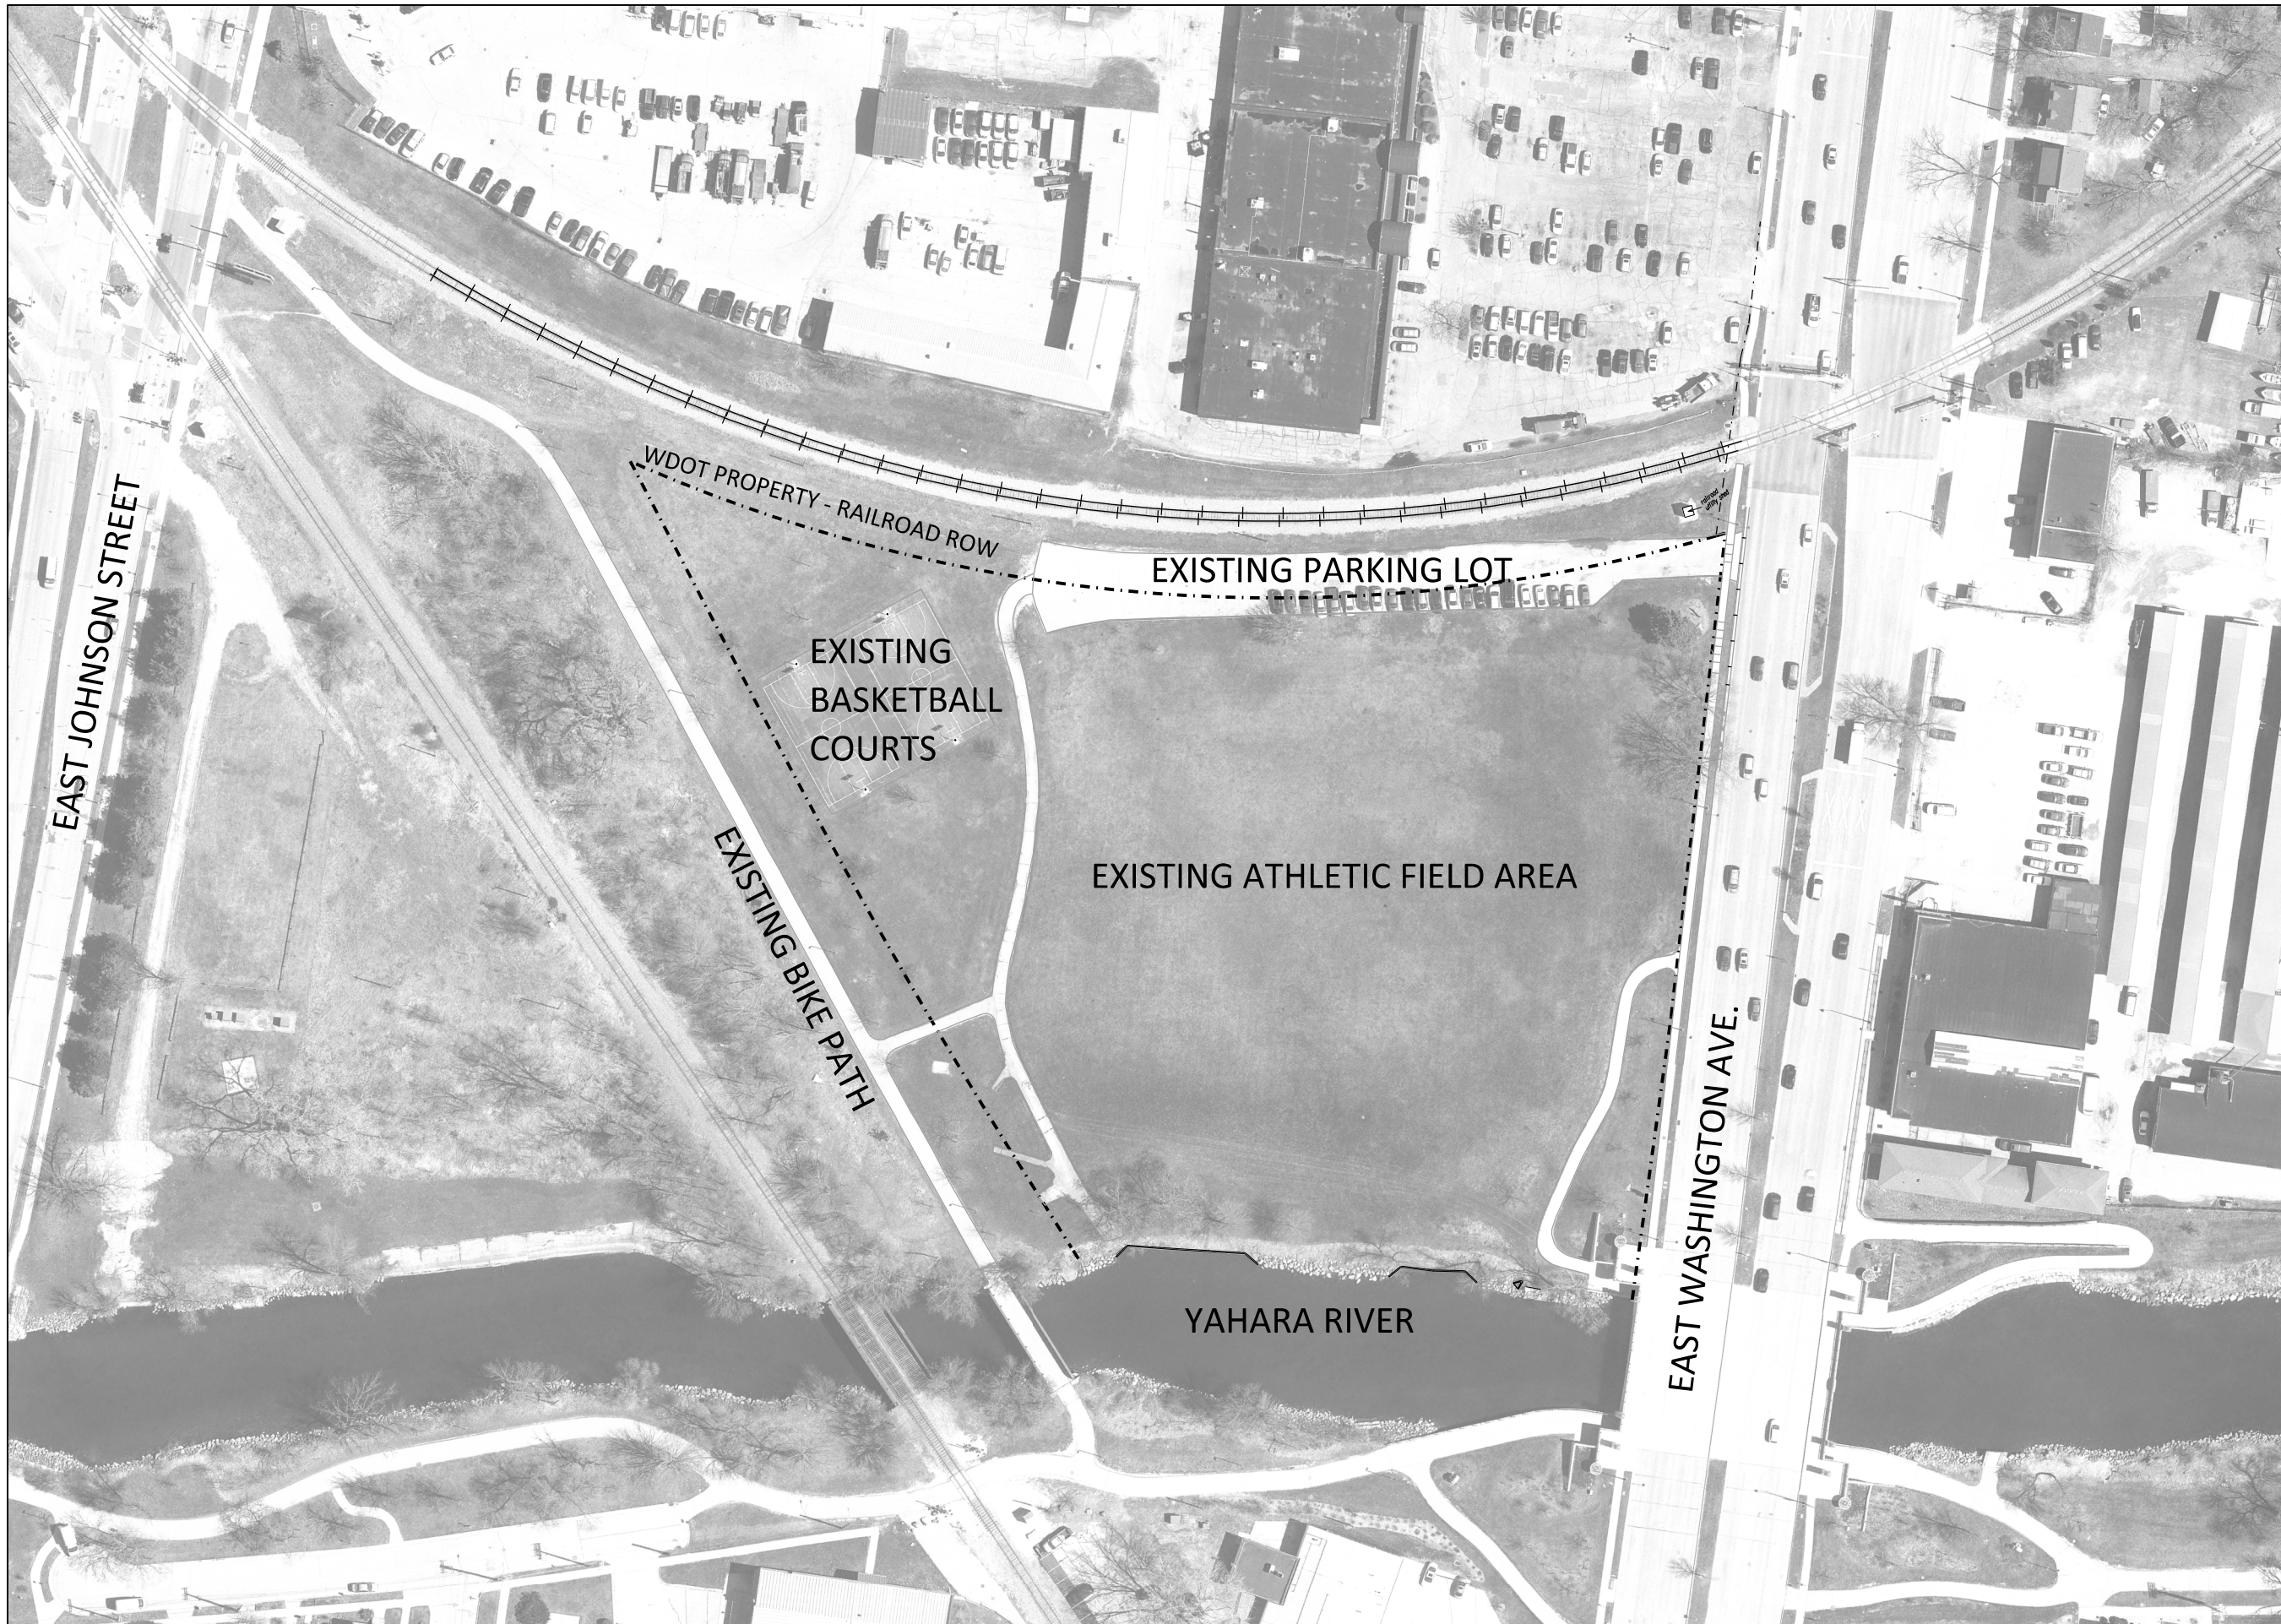

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 PARKS**

Graphical Scale  
 0 100 ft 

PROJECT:  
*BURR JONES  
 PARK SITE  
 IMPROVEMENTS*

*BURR JONES PARK  
 1820 E. WASHINGTON AVE.  
 MADISON, WI 53704*


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ITEM	DATE
Drawing by: MS	05-23-19
Advertised to bid:	05-30-19

PUBLIC WORKS PROJECT #:  
**8359**

SHEET TITLE:  
**PROJECT LOCATION  
 PLAN**

SHEET NUMBER:  
**1.0**

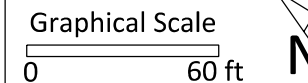

PROJECT:  
**BURR JONES  
 PARK SITE  
 IMPROVEMENTS**

**BURR JONES PARK  
 1820 E. WASHINGTON AVE.  
 MADISON, WI 53704**


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ITEM	DATE
Drawing by: MS	05-23-19
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PUBLIC WORKS PROJECT #:  
**8359**

SHEET TITLE:  
**EXISTING SITE  
 PLAN**

SHEET NUMBER:  
**2.0**




**LEGEND**

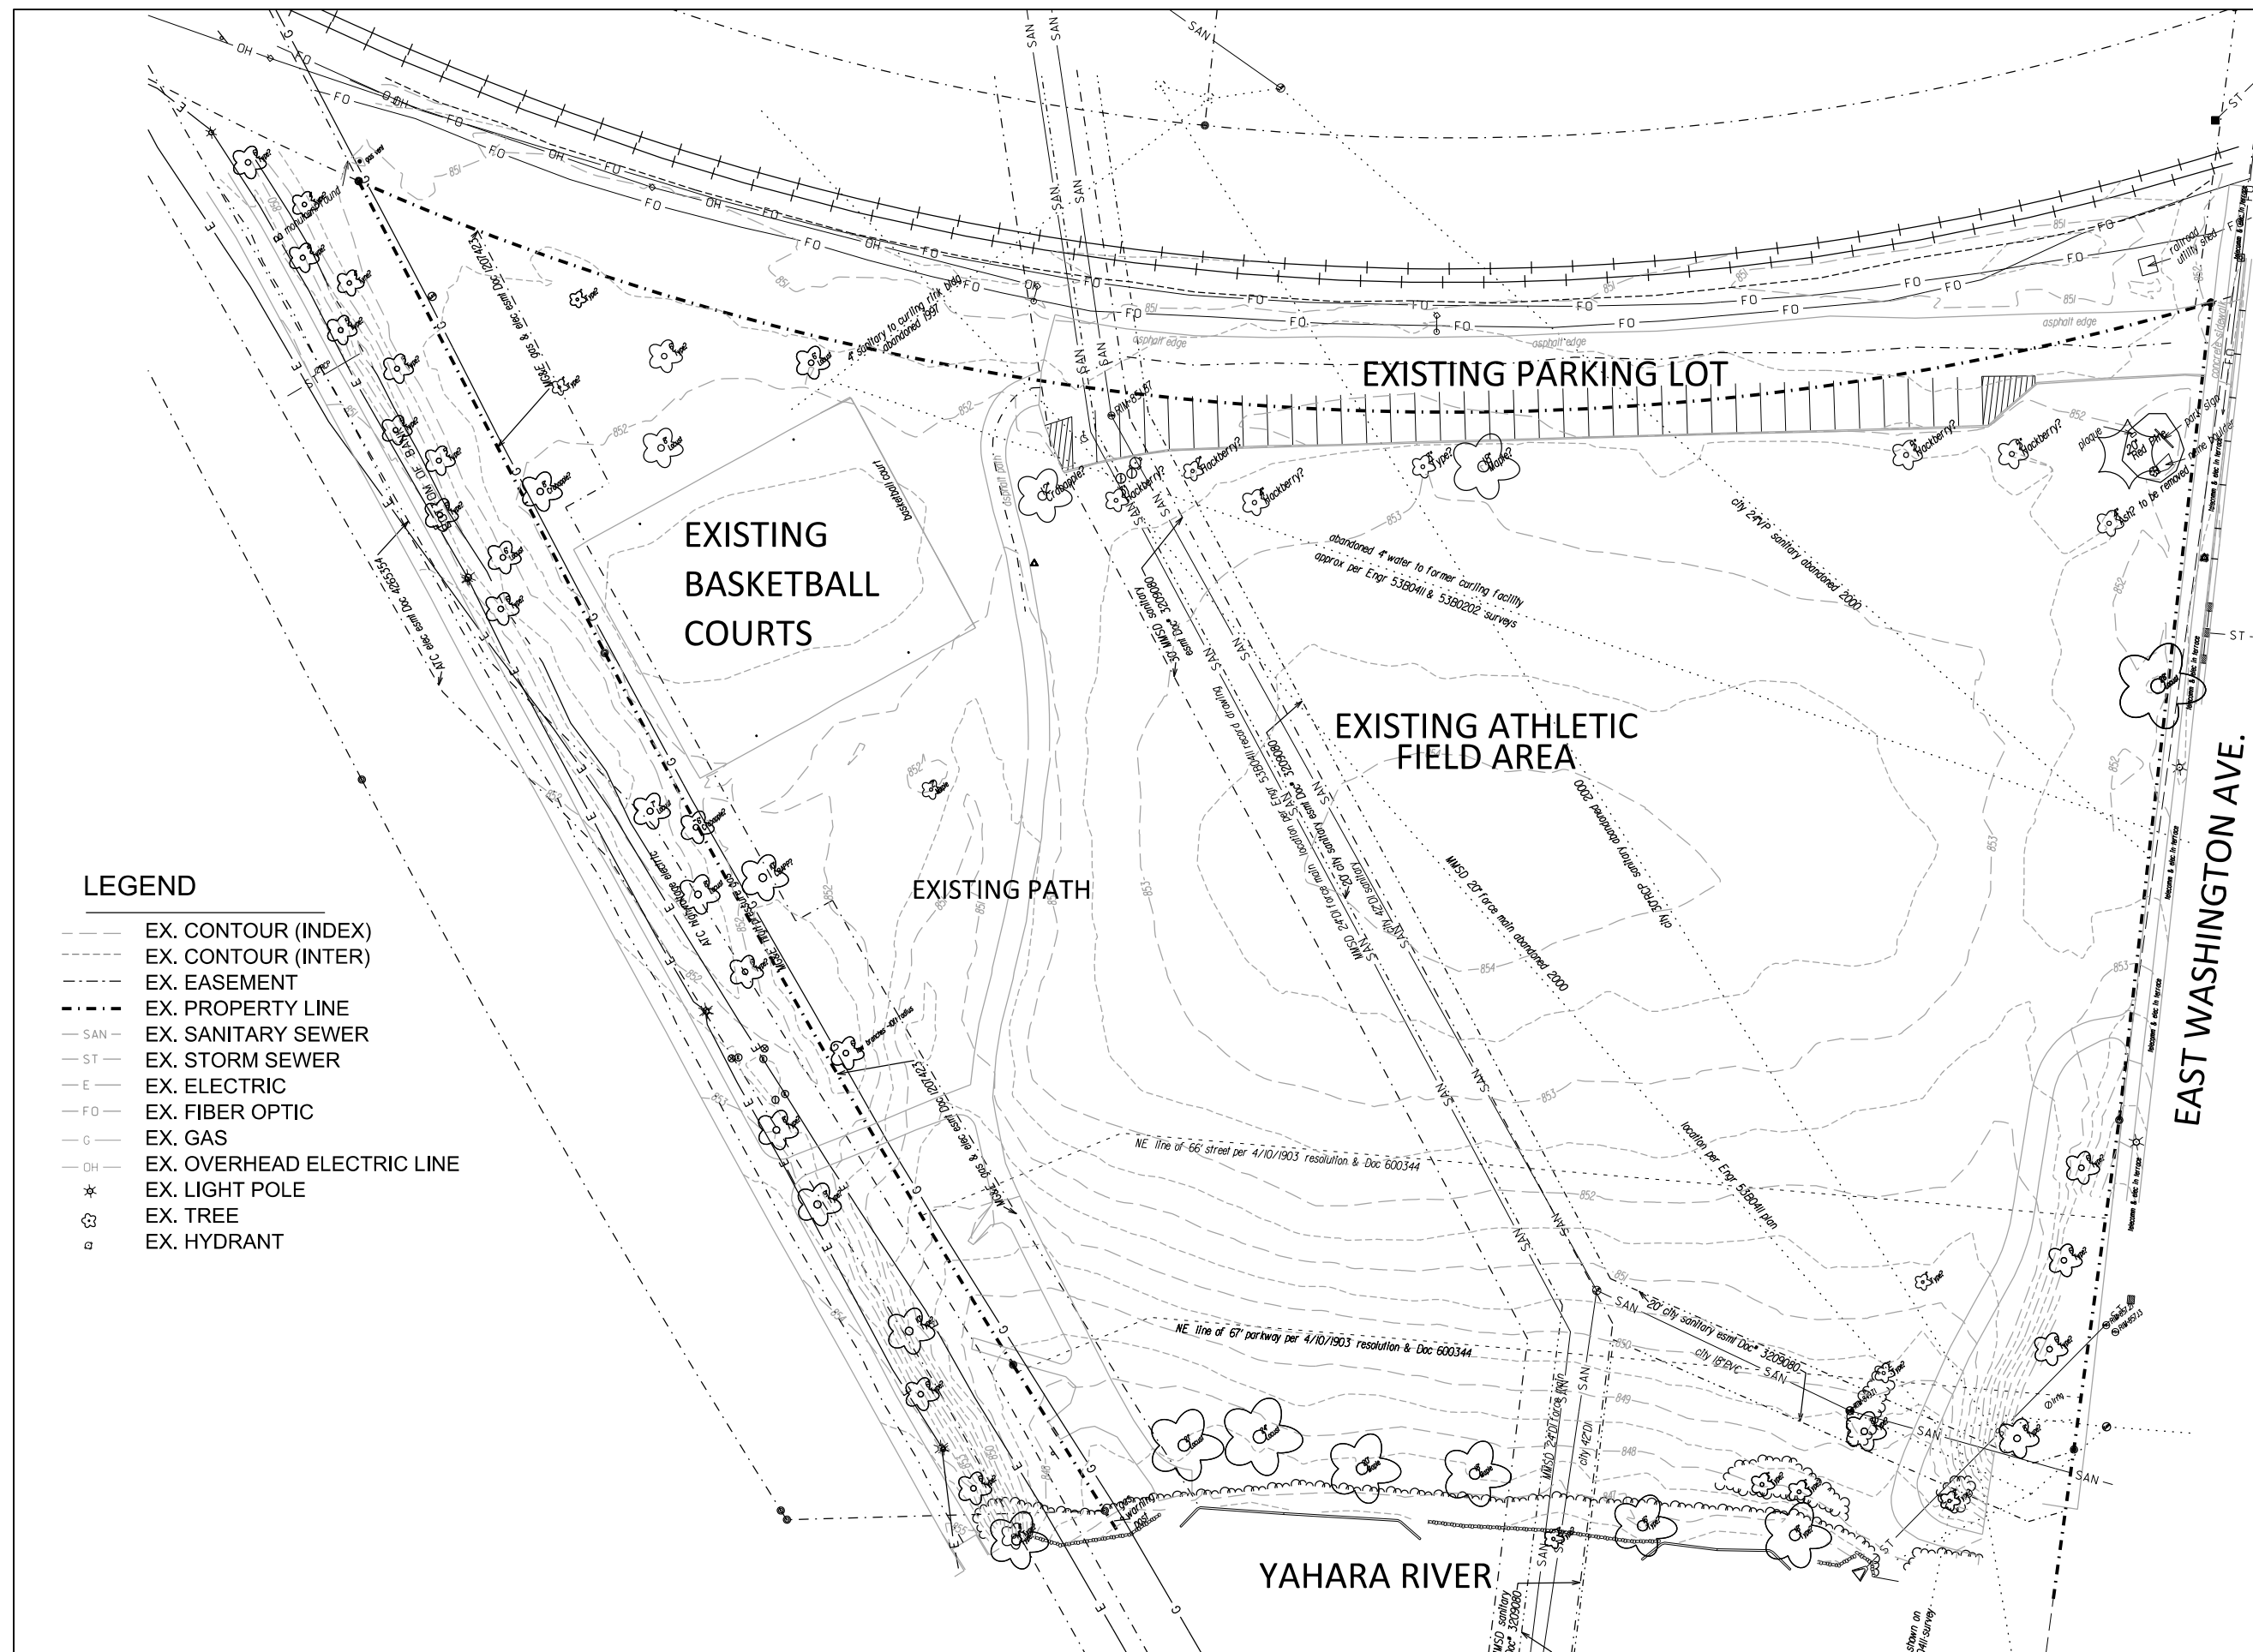- EX. CONTOUR (INDEX)
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- - - EX. EASEMENT
- - - EX. PROPERTY LINE
- SAN - EX. SANITARY SEWER
- ST - EX. STORM SEWER
- E - EX. ELECTRIC
- FO - EX. FIBER OPTIC
- G - EX. GAS
- OH - EX. OVERHEAD ELECTRIC LINE
- ☆ EX. LIGHT POLE
- ☼ EX. TREE
- EX. HYDRANT

City of Madison  
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PROJECT:  
**BURR JONES  
 PARK SITE  
 IMPROVEMENTS**

**BURR JONES PARK  
 1820 E. WASHINGTON AVE.  
 MADISON, WI 53704**

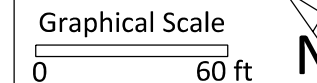
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PUBLIC WORKS PROJECT #:  
**8359**

SHEET TITLE:  
**EXISTING UTILITY  
 EASEMENTS PLAN**

SHEET NUMBER:  
**2.1**




**LEGEND**
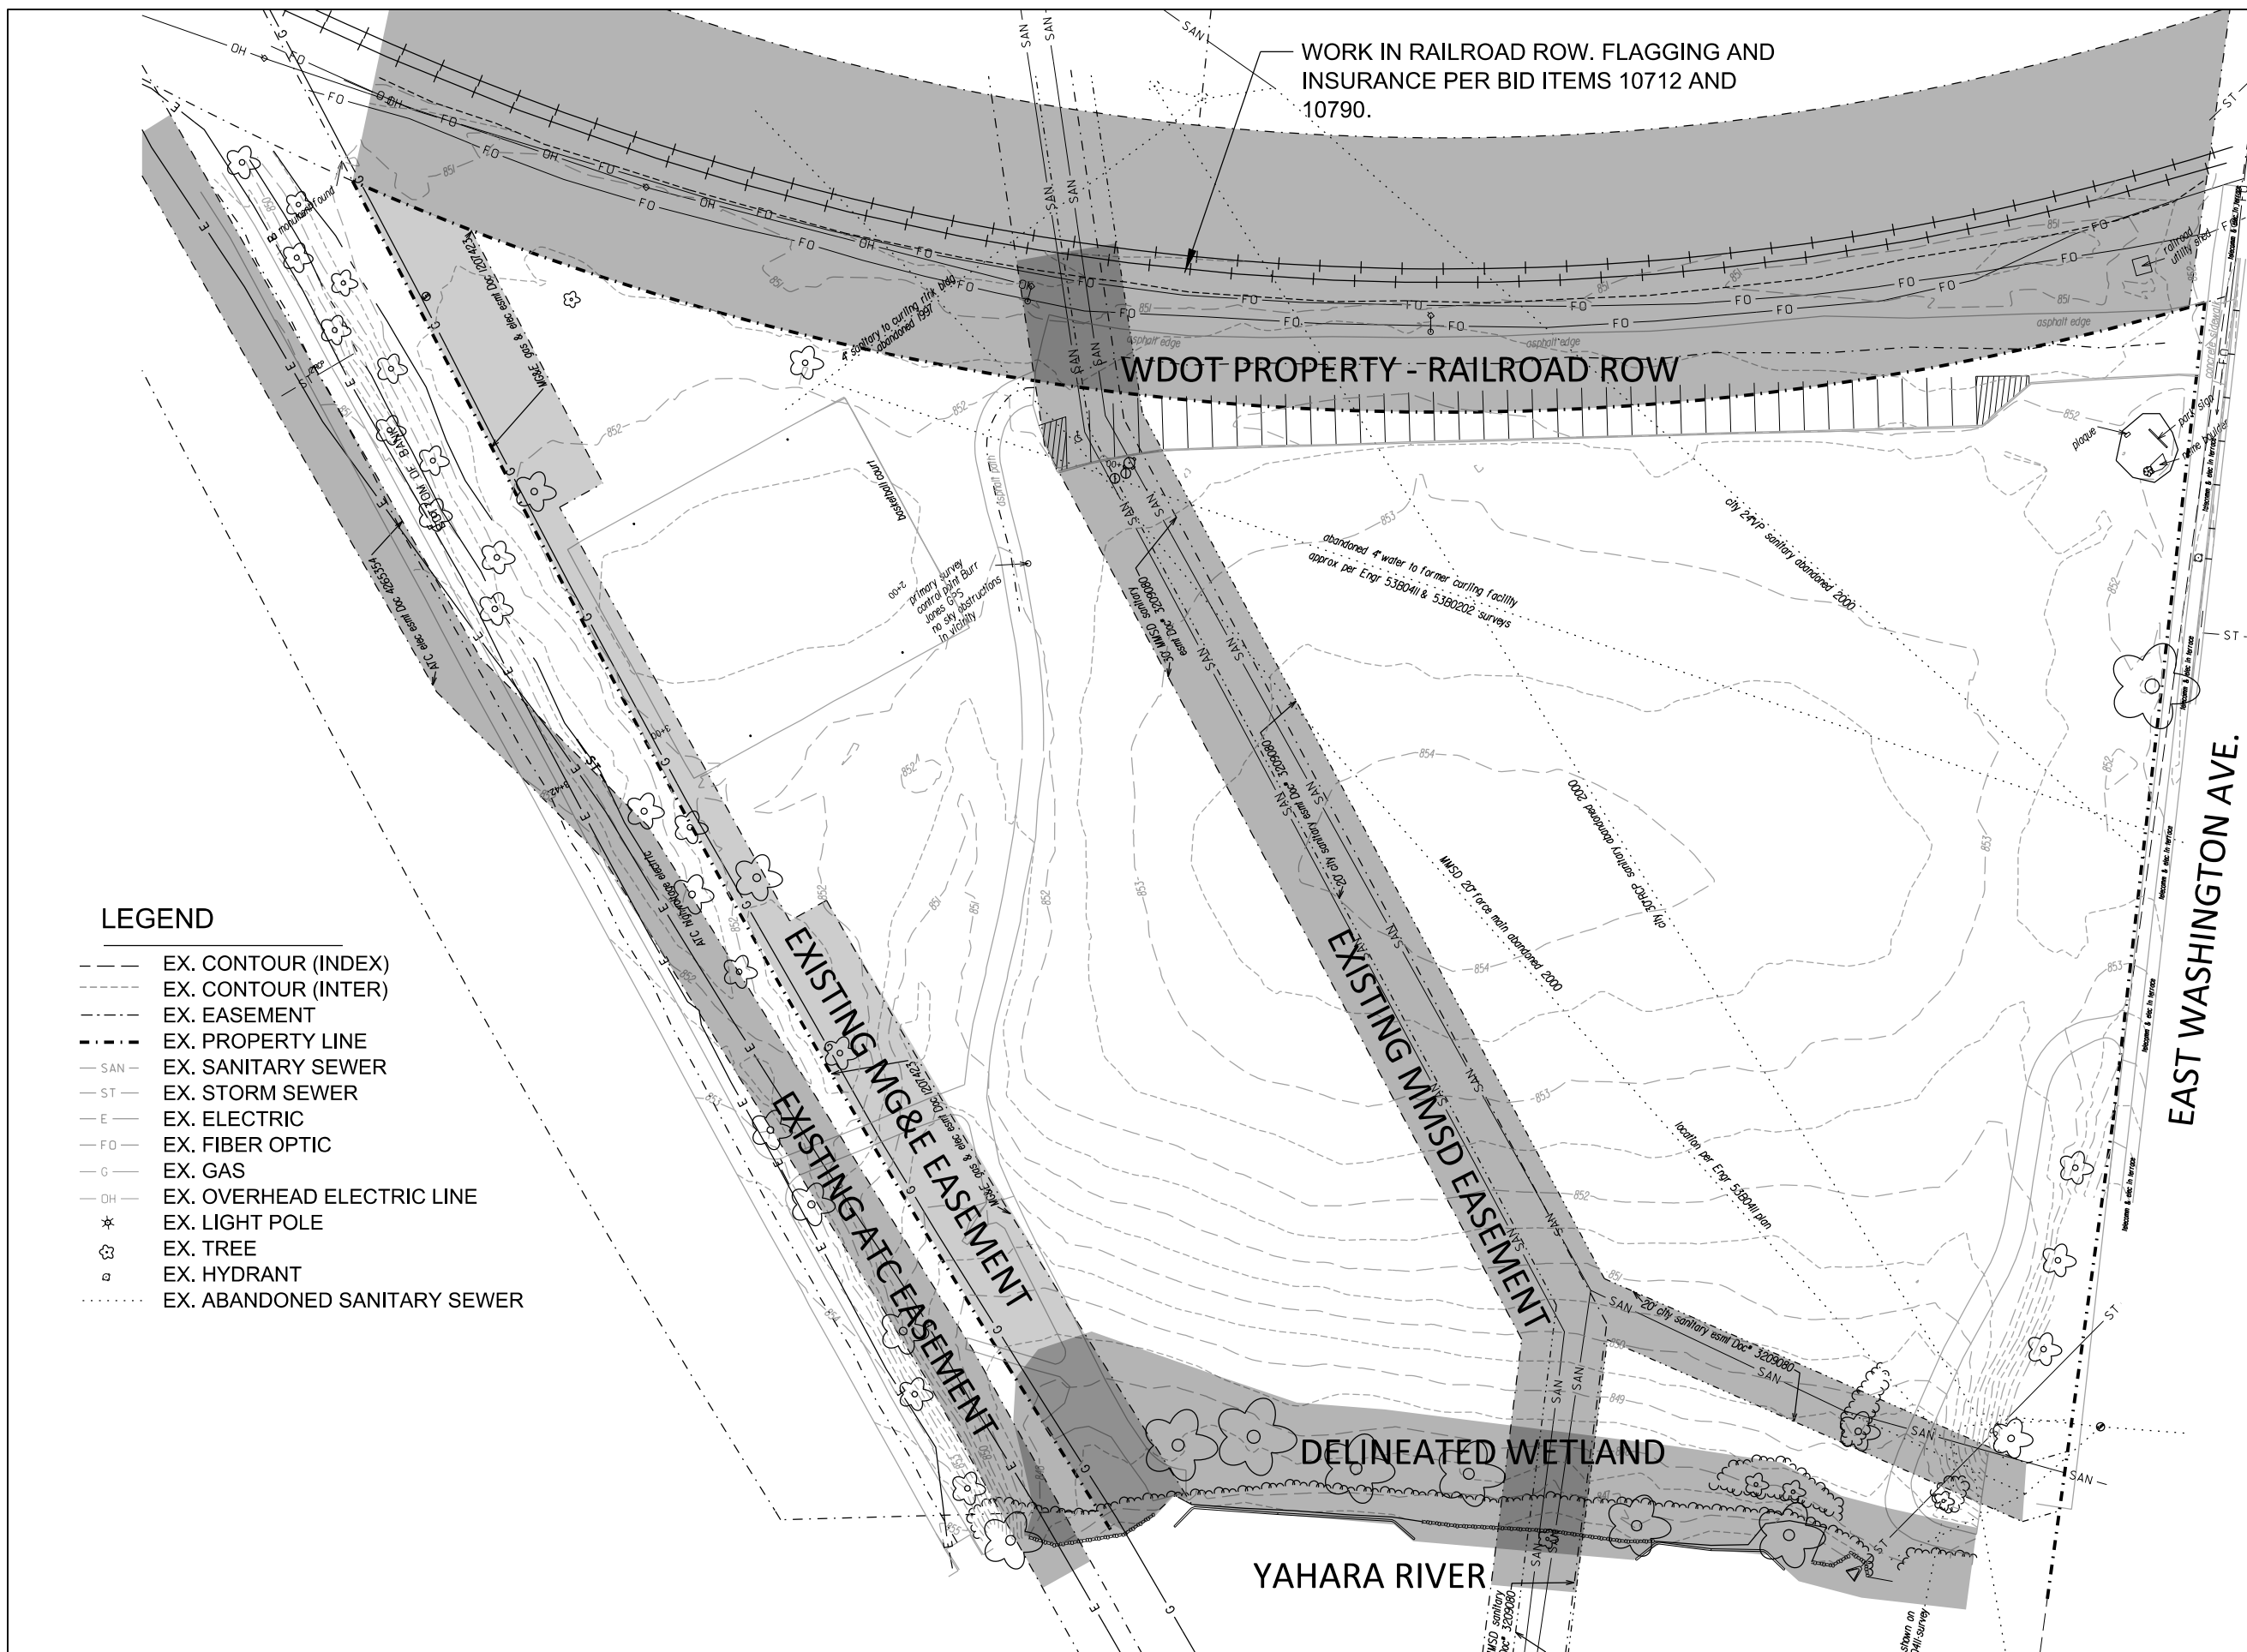
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- \* EX. LIGHT POLE
- ⊗ EX. TREE
- ⊙ EX. HYDRANT
- ⋯ EX. ABANDONED SANITARY SEWER

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Graphical Scale  
0 60 ft 

PROJECT:  
*BURR JONES  
PARK SITE  
IMPROVEMENTS*

*BURR JONES PARK  
1820 E. WASHINGTON AVE.  
MADISON, WI 53704*


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Advertised to bid:	05-30-19

PUBLIC WORKS PROJECT #:  
**8359**

SHEET TITLE:  
**SITE ACCESS, EROSION  
CONTROL AND SITE  
PROTECTION PLAN**

SHEET NUMBER:  
**3.0**

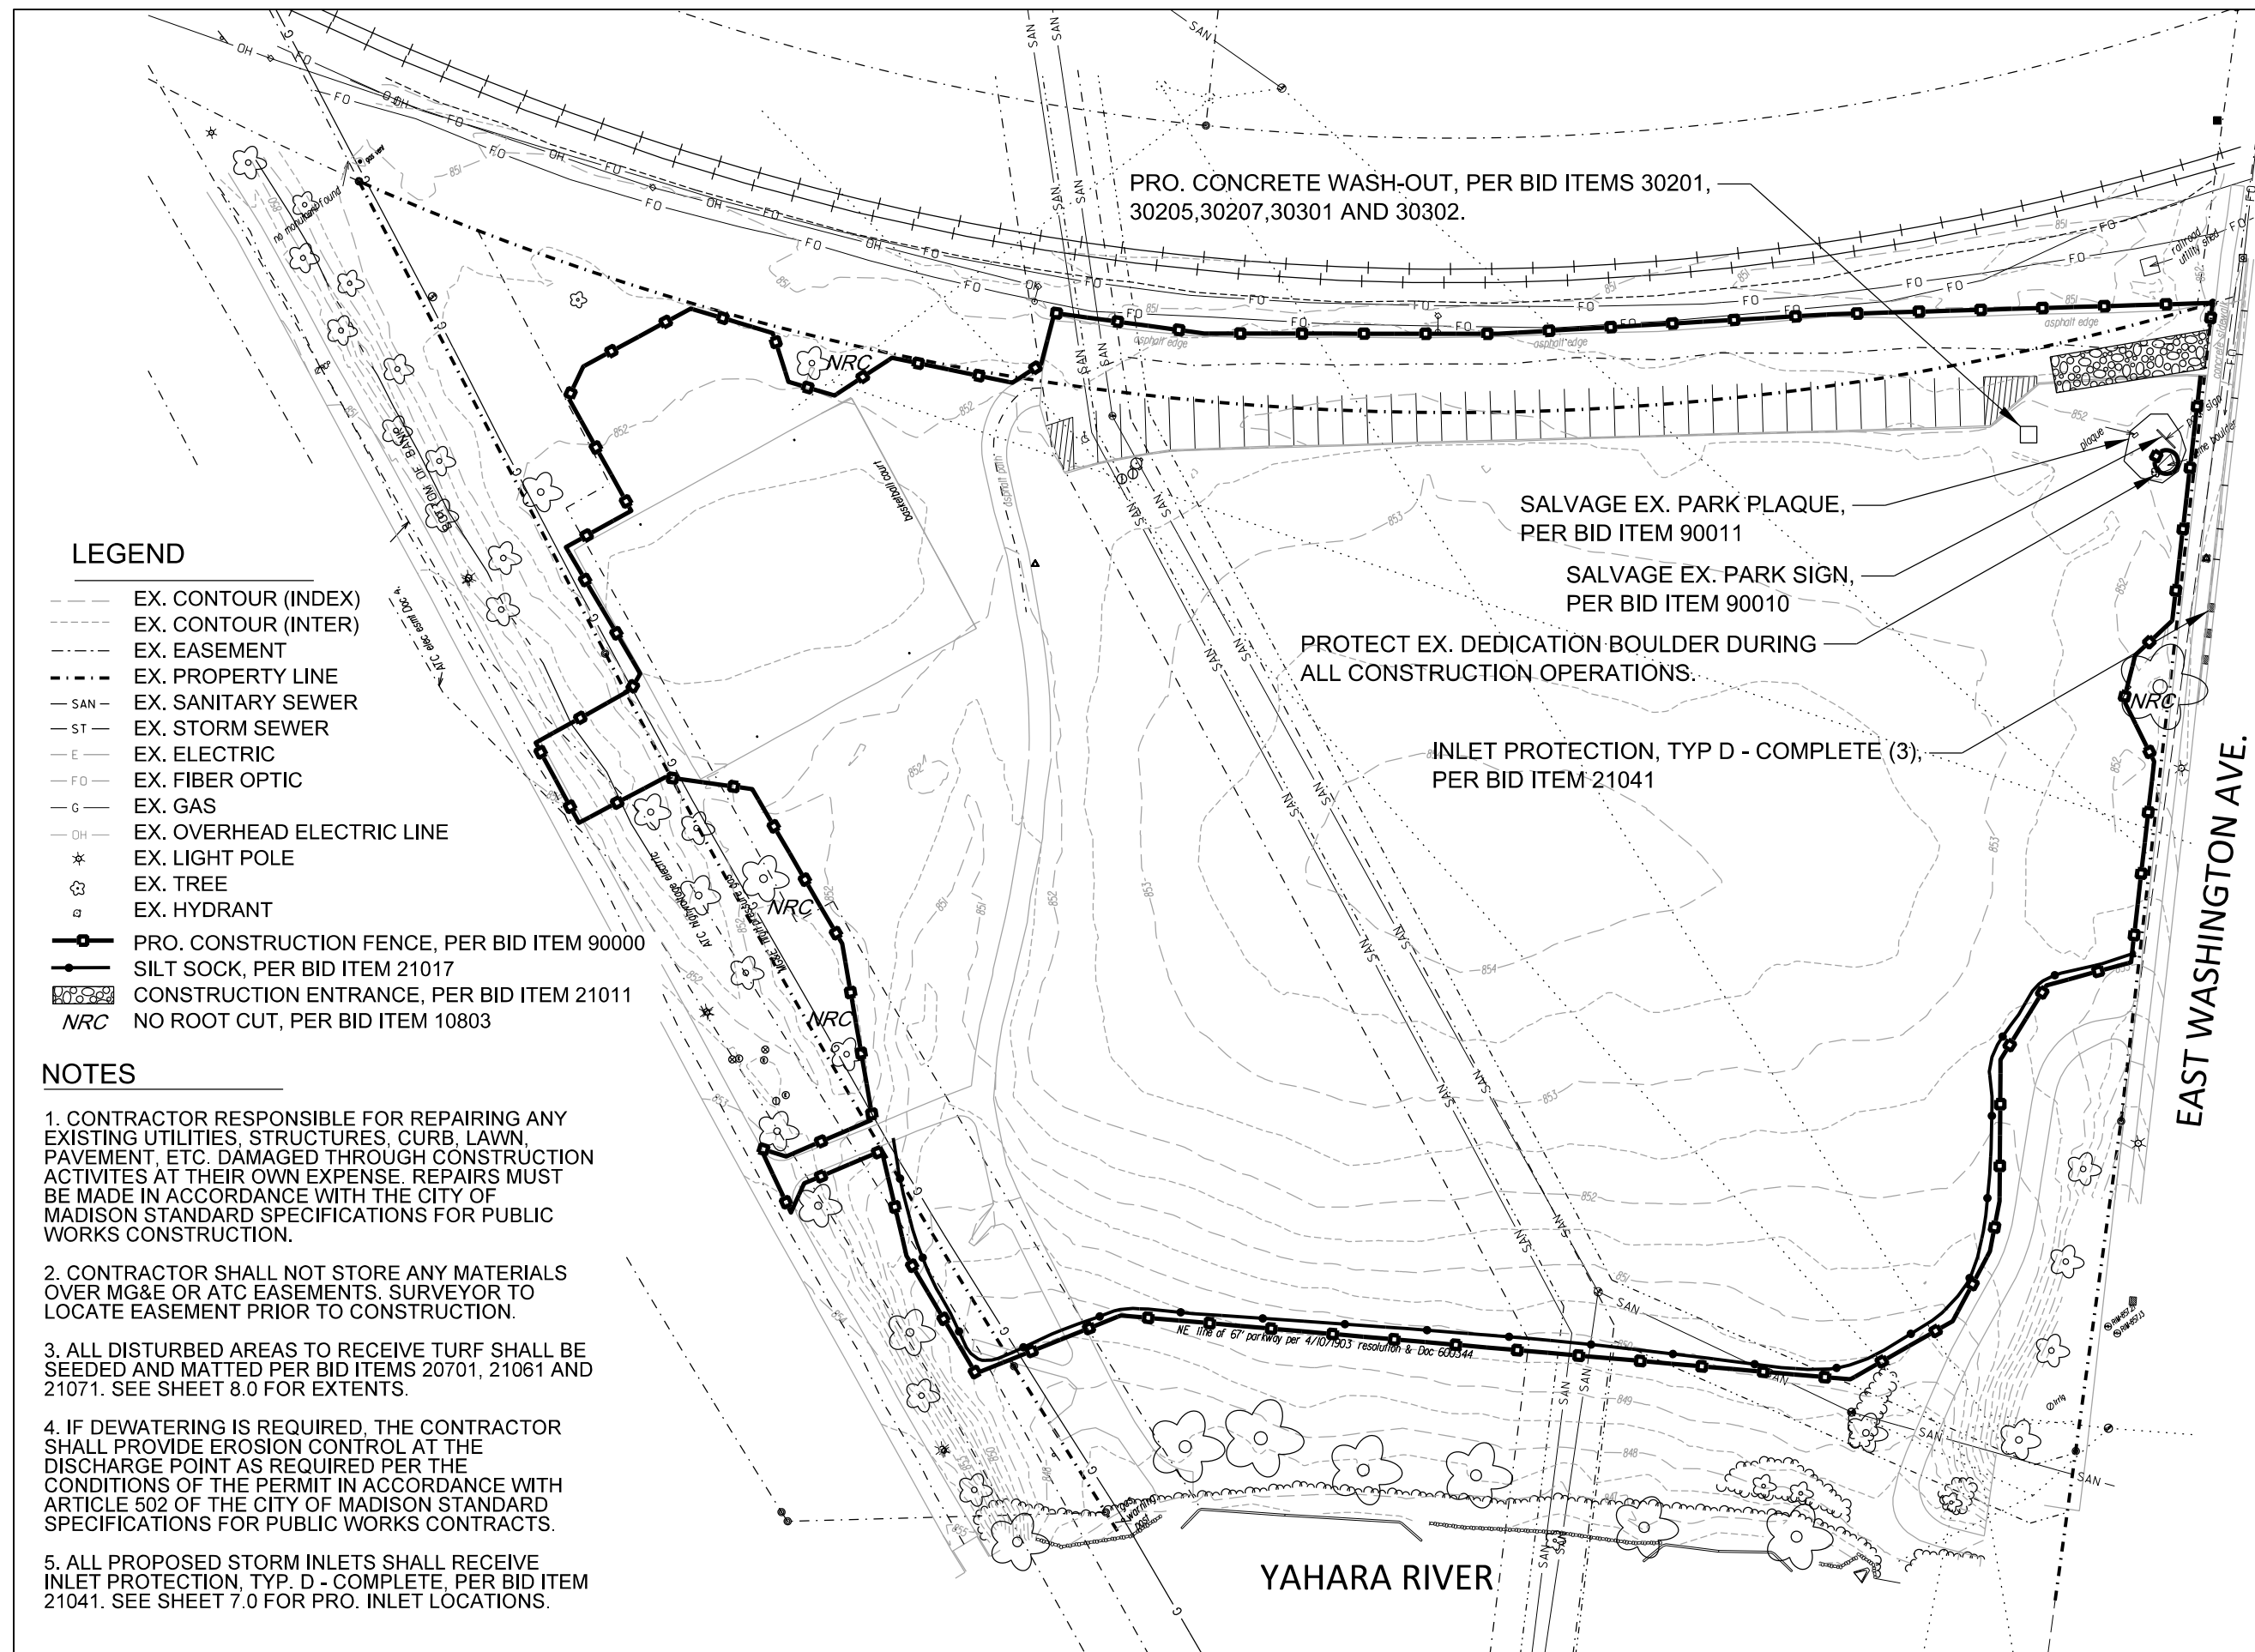


**LEGEND**

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- OH - EX. OVERHEAD ELECTRIC LINE
- \* EX. LIGHT POLE
- ⊛ EX. TREE
- ⊠ EX. HYDRANT
- PRO. CONSTRUCTION FENCE, PER BID ITEM 90000
- SILT SOCK, PER BID ITEM 21017
- ▣ CONSTRUCTION ENTRANCE, PER BID ITEM 21011
- NRC NO ROOT CUT, PER BID ITEM 10803

**NOTES**

1. CONTRACTOR RESPONSIBLE FOR REPAIRING ANY EXISTING UTILITIES, STRUCTURES, CURB, LAWN, PAVEMENT, ETC. DAMAGED THROUGH CONSTRUCTION ACTIVITIES AT THEIR OWN EXPENSE. REPAIRS MUST BE MADE IN ACCORDANCE WITH THE CITY OF MADISON STANDARD SPECIFICATIONS FOR PUBLIC WORKS CONSTRUCTION.
2. CONTRACTOR SHALL NOT STORE ANY MATERIALS OVER MG&E OR ATC EASEMENTS. SURVEYOR TO LOCATE EASEMENT PRIOR TO CONSTRUCTION.
3. ALL DISTURBED AREAS TO RECEIVE TURF SHALL BE SEEDED AND MATTED PER BID ITEMS 20701, 21061 AND 21071. SEE SHEET 8.0 FOR EXTENTS.
4. IF DEWATERING IS REQUIRED, THE CONTRACTOR SHALL PROVIDE EROSION CONTROL AT THE DISCHARGE POINT AS REQUIRED PER THE CONDITIONS OF THE PERMIT IN ACCORDANCE WITH ARTICLE 502 OF THE CITY OF MADISON STANDARD SPECIFICATIONS FOR PUBLIC WORKS CONTRACTS.
5. ALL PROPOSED STORM INLETS SHALL RECEIVE INLET PROTECTION, TYP. D - COMPLETE, PER BID ITEM 21041. SEE SHEET 7.0 FOR PRO. INLET LOCATIONS.

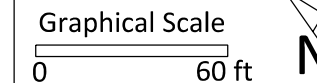

PROJECT:  
**BURR JONES  
 PARK SITE  
 IMPROVEMENTS**

**BURR JONES PARK  
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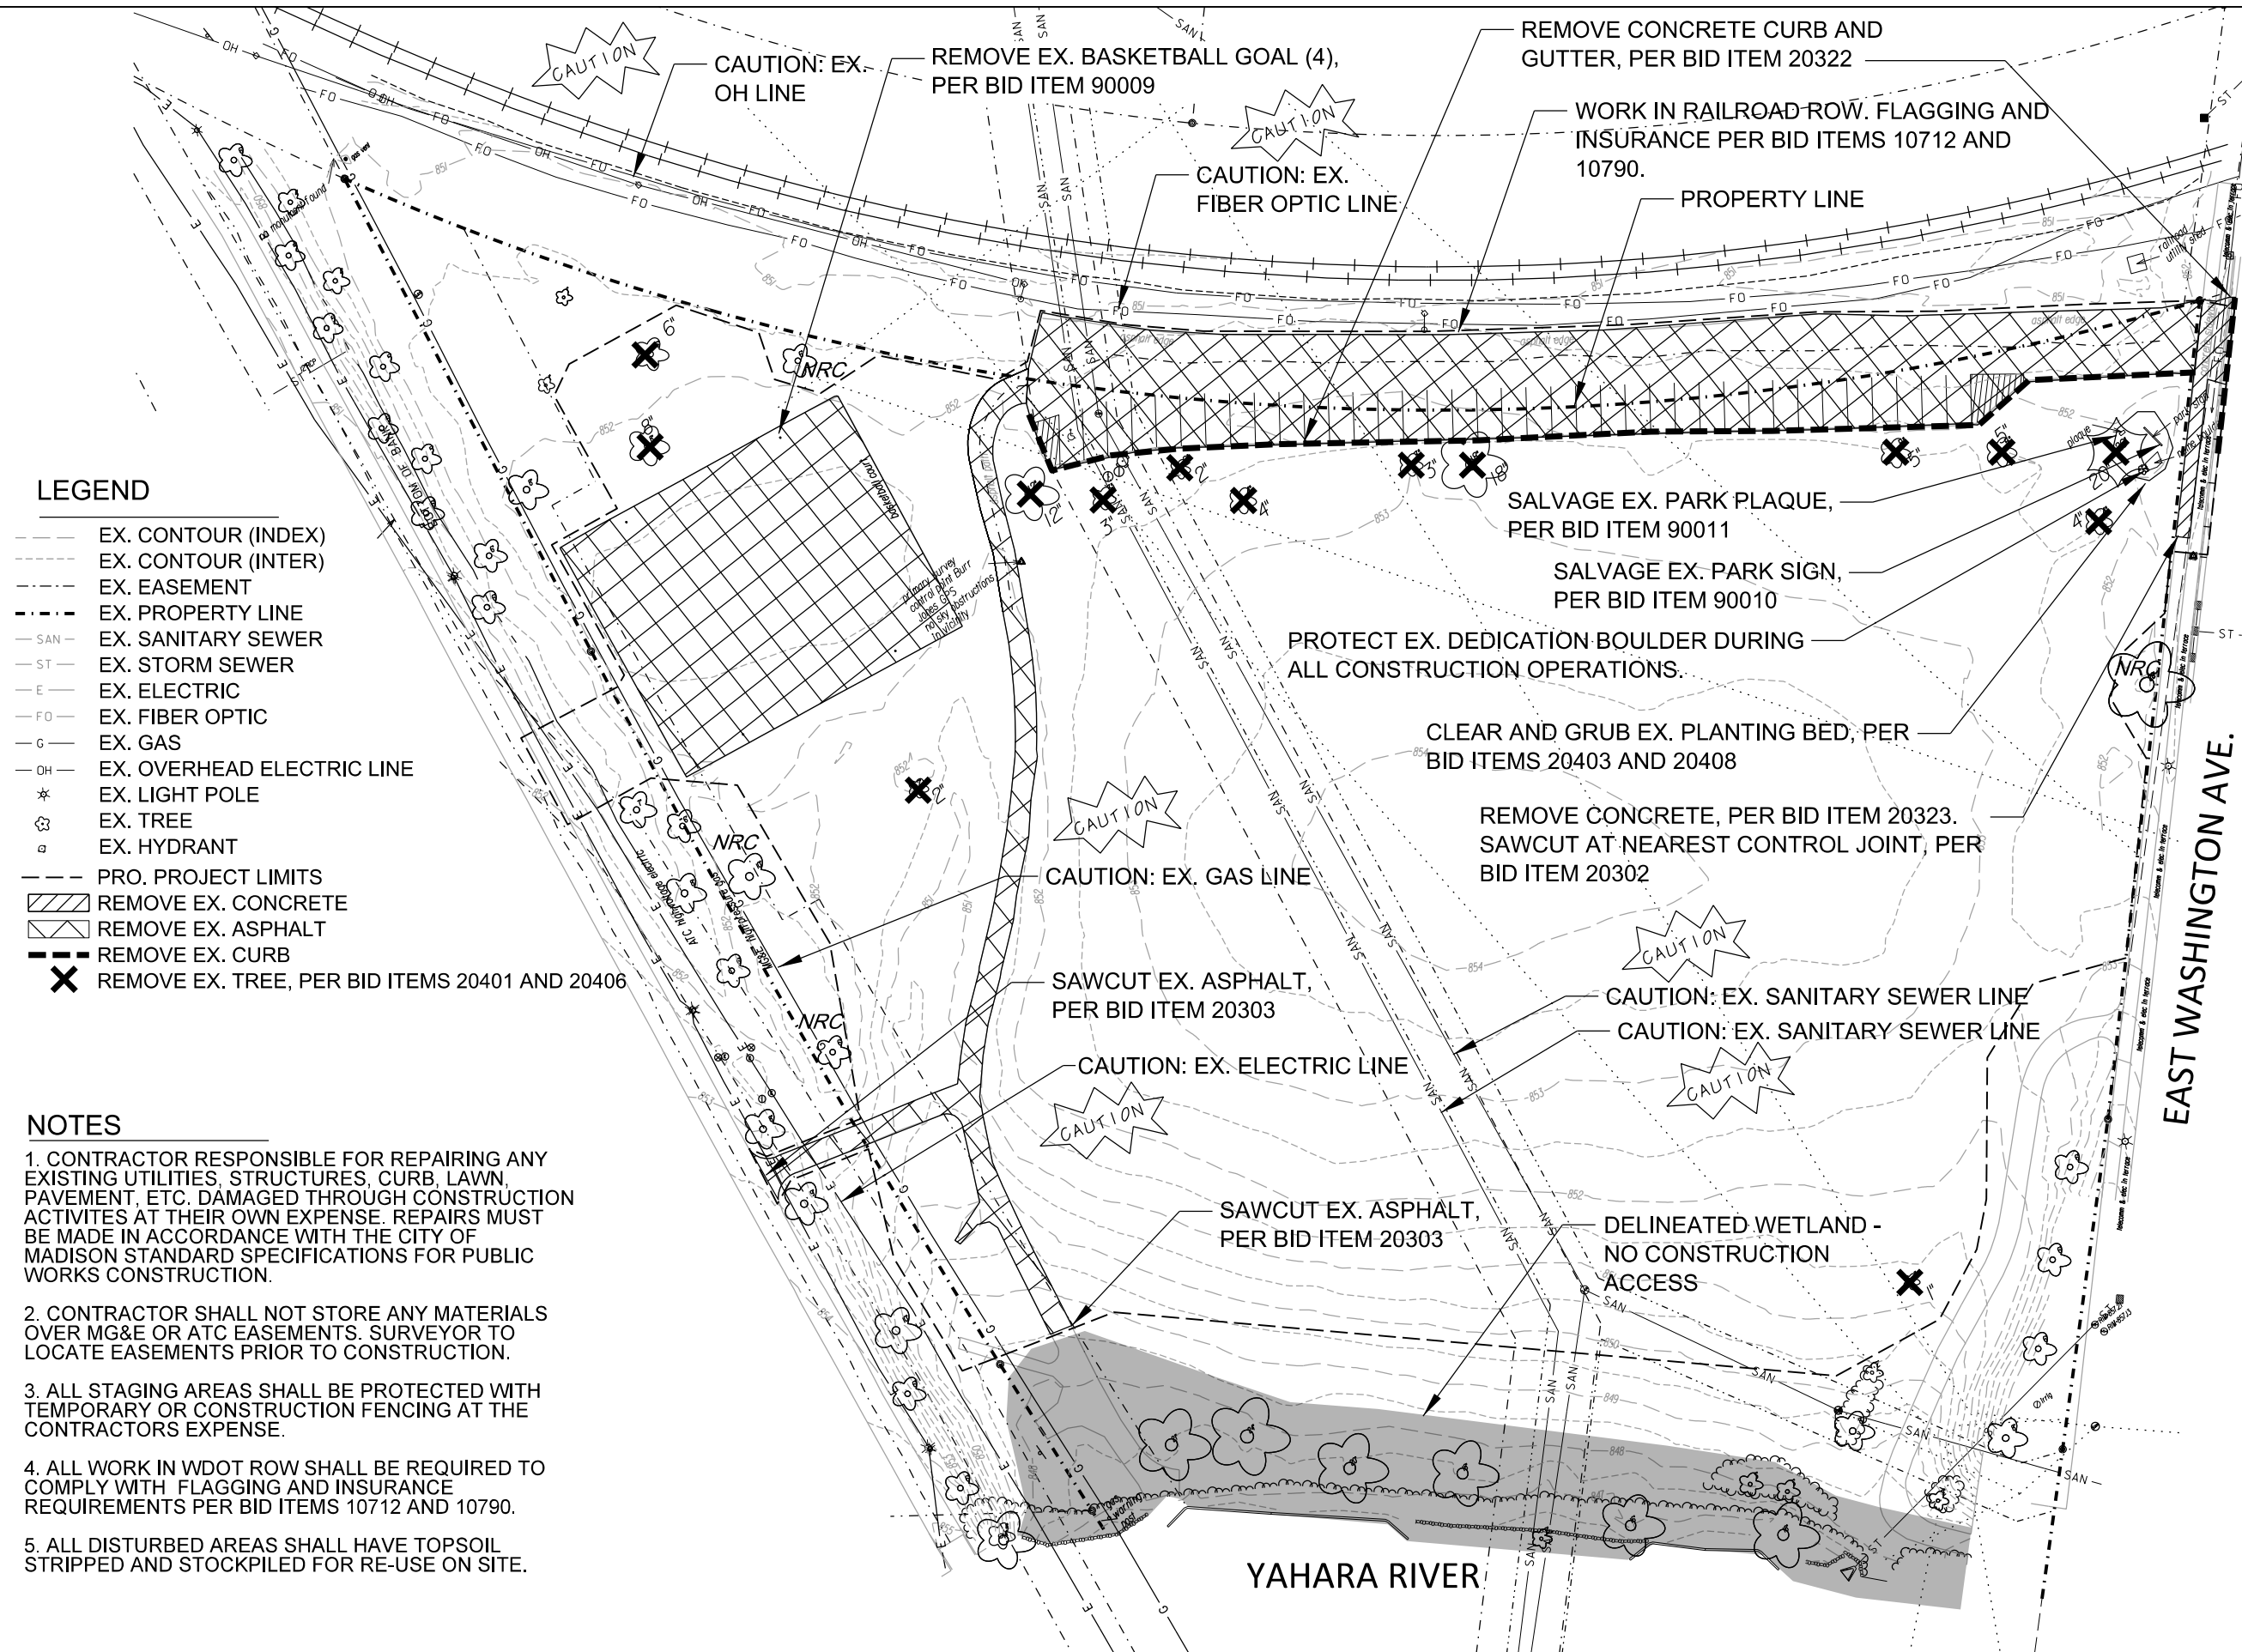
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Advertised to bid:	05-30-19

PUBLIC WORKS PROJECT #:  
**8359**

SHEET TITLE:  
**DEMOLITION  
 PLAN**

SHEET NUMBER:  
**4.0**



**LEGEND**


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- G - EX. GAS
- OH - EX. OVERHEAD ELECTRIC LINE
- \* EX. LIGHT POLE
- ⊗ EX. TREE
- ⊙ EX. HYDRANT
- - - PRO. PROJECT LIMITS
- ▨ REMOVE EX. CONCRETE
- ▧ REMOVE EX. ASPHALT
- - - REMOVE EX. CURB
- ✕ REMOVE EX. TREE, PER BID ITEMS 20401 AND 20406

**NOTES**

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2. CONTRACTOR SHALL NOT STORE ANY MATERIALS OVER MG&E OR ATC EASEMENTS. SURVEYOR TO LOCATE EASEMENTS PRIOR TO CONSTRUCTION.
3. ALL STAGING AREAS SHALL BE PROTECTED WITH TEMPORARY OR CONSTRUCTION FENCING AT THE CONTRACTORS EXPENSE.
4. ALL WORK IN WDOT ROW SHALL BE REQUIRED TO COMPLY WITH FLAGGING AND INSURANCE REQUIREMENTS PER BID ITEMS 10712 AND 10790.
5. ALL DISTURBED AREAS SHALL HAVE TOPSOIL STRIPPED AND STOCKPILED FOR RE-USE ON SITE.

City of Madison  
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**PARKS DIVISION**  
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**MADISON  
 PARKS**

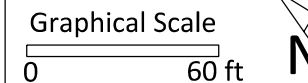

PROJECT:  
**BURR JONES  
 PARK SITE  
 IMPROVEMENTS**

**BURR JONES PARK  
 1820 E. WASHINGTON AVE.  
 MADISON, WI 53704**


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ITEM	DATE
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Advertised to bid:	05-30-19

PUBLIC WORKS PROJECT #:  
**8359**

SHEET TITLE:  
**SITE PLAN**

SHEET NUMBER:  
**5.0**

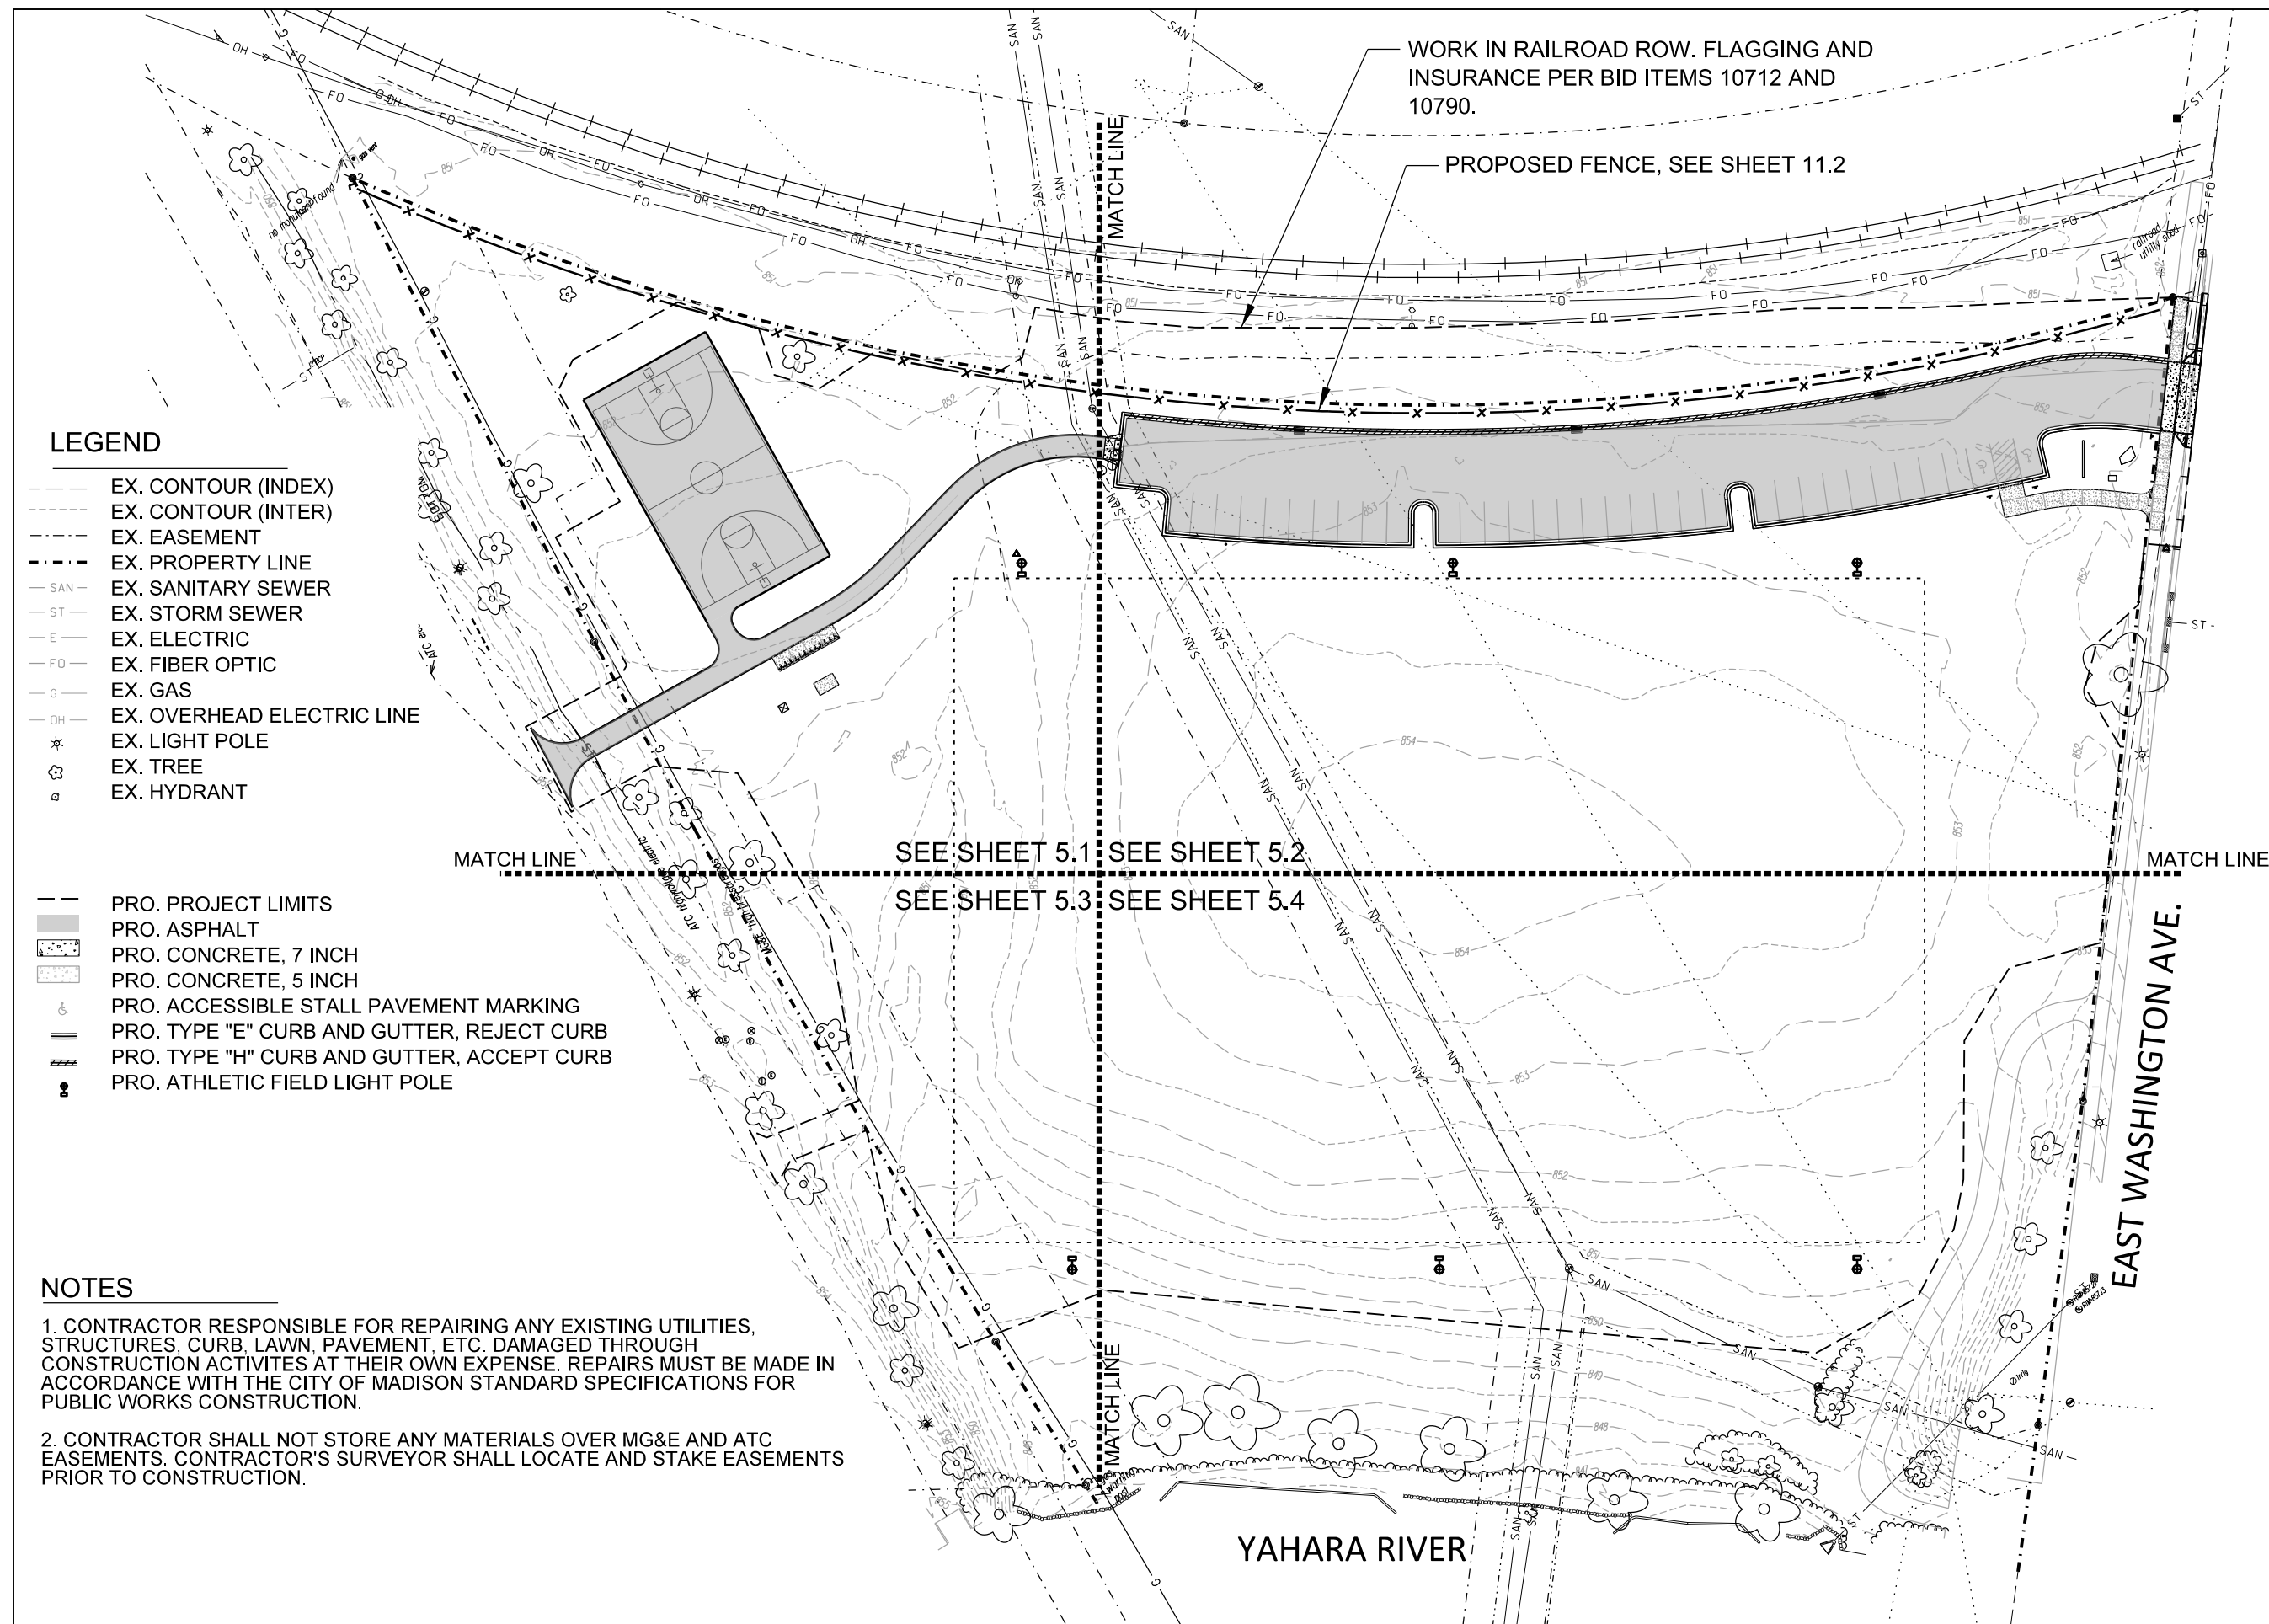

**LEGEND**

- EX. CONTOUR (INDEX)
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- - - EX. EASEMENT
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- G - EX. GAS
- OH - EX. OVERHEAD ELECTRIC LINE
- \* EX. LIGHT POLE
- ⊛ EX. TREE
- ⊠ EX. HYDRANT

- - - PRO. PROJECT LIMITS
- ▒ PRO. ASPHALT
- ▒ PRO. CONCRETE, 7 INCH
- ▒ PRO. CONCRETE, 5 INCH
- ♿ PRO. ACCESSIBLE STALL PAVEMENT MARKING
- ▒▒▒ PRO. TYPE "E" CURB AND GUTTER, REJECT CURB
- ▒▒▒ PRO. TYPE "H" CURB AND GUTTER, ACCEPT CURB
- ⦿ PRO. ATHLETIC FIELD LIGHT POLE

**NOTES**

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Department of Public Works  
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Madison, WI 53703

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**MADISON  
PARKS**

Graphical Scale  
0 30 ft

PROJECT:  
**BURR JONES  
PARK SITE  
IMPROVEMENTS**

**BURR JONES PARK**  
1820 E. WASHINGTON AVE.  
MADISON, WI 53704

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ITEM	DATE
Drawing by: MS	05-23-19
Advertised to bid:	05-30-19

PUBLIC WORKS PROJECT #:  
**8359**

SHEET TITLE:  
**SITE PLAN - BASKETBALL  
COURT AND PATH**

SHEET NUMBER:  
**5.1**

**LEGEND**

- EX. CONTOUR (INDEX)
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- G - EX. GAS
- OH - EX. OVERHEAD ELECTRIC LINE
- EX. LIGHT POLE
- EX. TREE
- EX. HYDRANT

- PRO. PROJECT LIMITS
- PRO. ASPHALT
- PRO. CONCRETE, 7 INCH
- PRO. CONCRETE, 5 INCH
- ==== PRO. TYPE "E" CURB AND GUTTER, REJECT CURB
- ==== PRO. TYPE "H" CURB AND GUTTER, ACCEPT CURB
- PRO. ATHLETIC FIELD LIGHT POLE, PER BID ITEM 90013.

- PRO. ATHLETIC FIELD EXTENTS
- ST - PRO. STORM SEWER PIPE
- PRO. BICYCLE RACK

**NOTES**

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2. CONTRACTOR SHALL NOT STORE ANY MATERIALS WITHIN MG&E AND ATC EASEMENTS. CONTRACTOR'S SURVEYOR SHALL LOCATE AND STAKE EASEMENTS PRIOR TO CONSTRUCTION.

PRO. BASKETBALL GOAL (2),  
PER BID ITEM 90007.

8 INCH TYPE III STORM SEWER PIPE  
PER BID ITEM 50441.

CONTRACTOR SHALL PERFORM (2) ULO FOR EXISTING  
GAS LINE PRIOR TO EARTHWORK AND PATH  
CONSTRUCTION.

PRO. BASKETBALL COURT LINE PAINTING,  
PER BID ITEM 90008.

PRO. ELECTRICAL  
SYSTEM PANELS  
PER BID ITEM 90012.  
SEE SHEETS 9.0 AND  
9.1.

PRO. BICYCLE RACK (2),  
PER BID ITEM 90006.

PRO. MG&E TRANS. BY  
OTHER

MATCH LINE - SEE SHEET 5.3

MATCH LINE - SEE SHEET 5.2



**LEGEND**

- EX. CONTOUR (INDEX)
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- G - EX. GAS
- OH - EX. OVERHEAD ELECTRIC LINE
- ☀ EX. LIGHT POLE
- 🌳 EX. TREE
- ⊕ EX. HYDRANT
- - - PRO. PROJECT LIMITS
- ▒ PRO. ASPHALT
- ▒ PRO. CONCRETE, 7 INCH
- ▒ PRO. CONCRETE, 5 INCH

- Ⓟ PRO. TRAFFIC OR PARKING SIGN
- ♿ PRO. ACCESSIBLE STALL PAVEMENT MARKING
- ▬▬▬ PRO. TYPE "E" CURB AND GUTTER, REJECT CURB
- ▬▬▬ PRO. TYPE "H" CURB AND GUTTER, ACCEPT CURB
- Ⓛ PRO. ATHLETIC FIELD LIGHT POLE
- PRO. ATHLETIC FIELD EXTENTS

**NOTES**

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**City of Madison**  
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**PARKS DIVISION**  
 City-County Building, Suite 104  
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*play*  
**MADISON PARKS**

Graphical Scale  
 0 30 ft

PROJECT:  
**BURR JONES PARK SITE IMPROVEMENTS**

**BURR JONES PARK**  
 1820 E. WASHINGTON AVE.  
 MADISON, WI 53704


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ITEM	DATE
Drawing by: MS	05-23-19
Advised to bid:	05-30-19

PUBLIC WORKS PROJECT #:  
**8359**

SHEET TITLE:  
**SITE PLAN - PARKING LOT**

SHEET NUMBER:  
**5.2**

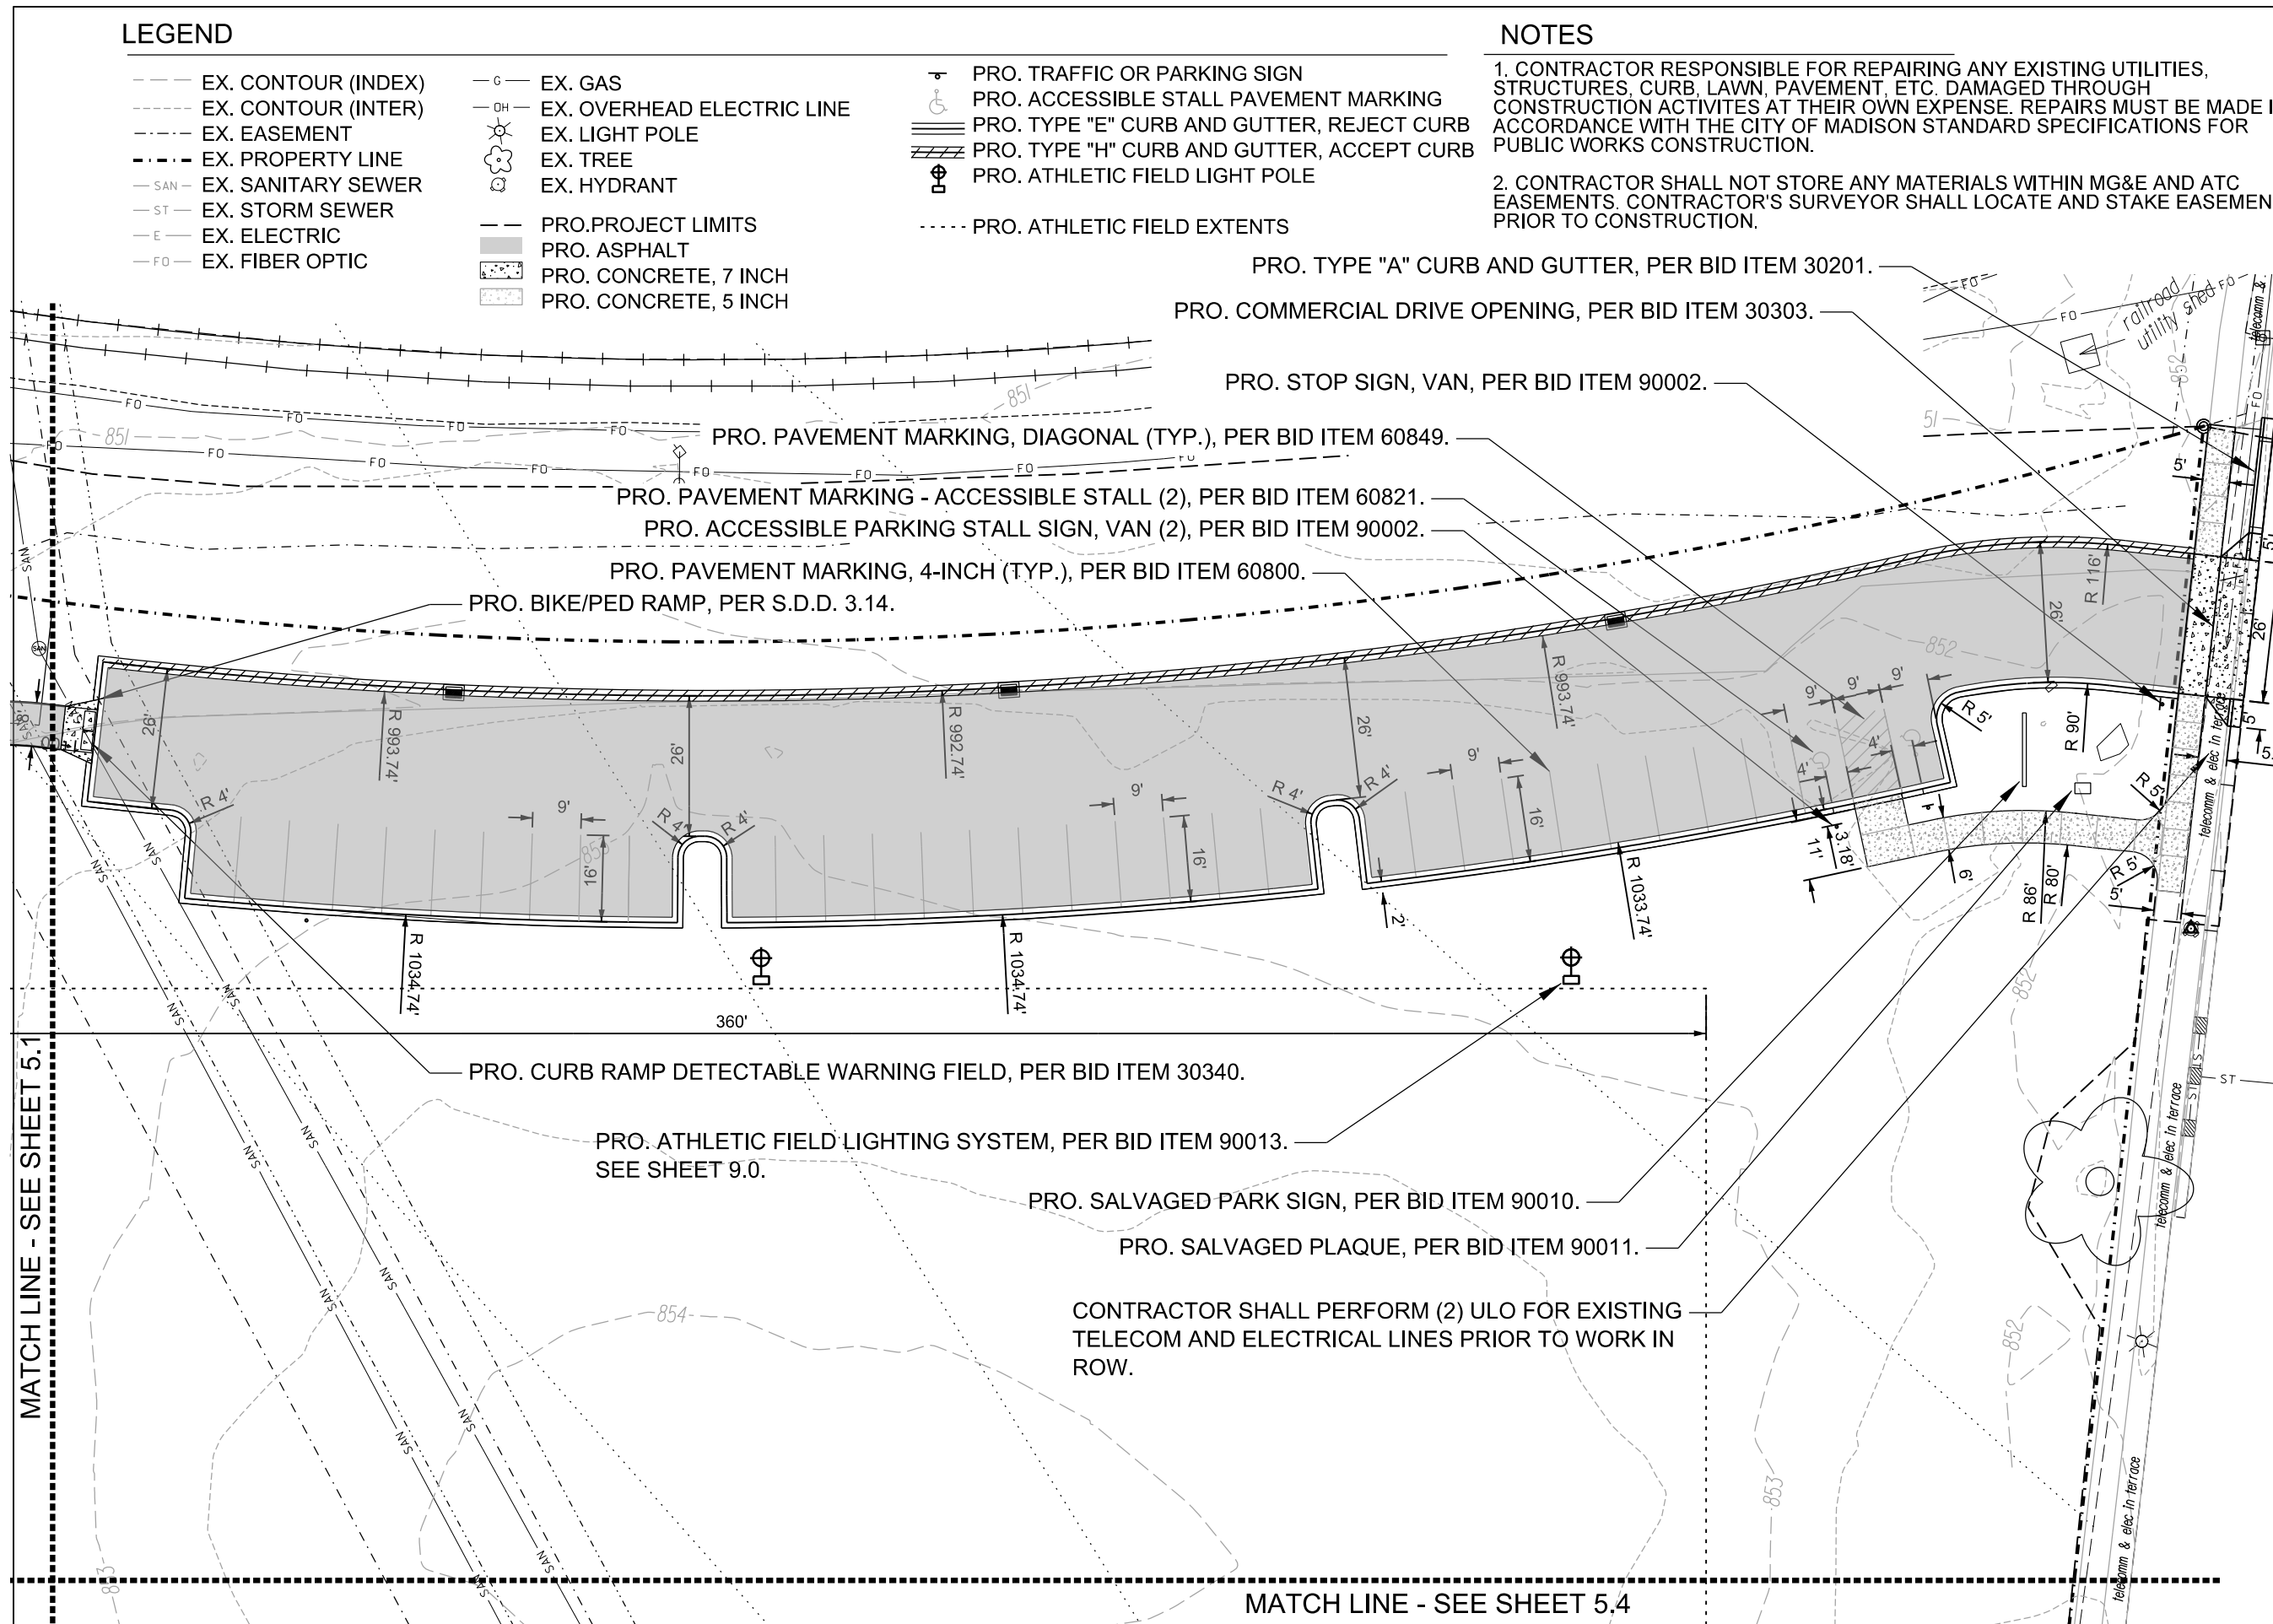

MATCH LINE - SEE SHEET 5.1

MATCH LINE - SEE SHEET 5.4

City of Madison  
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**MADISON  
PARKS**

Graphical Scale

0 30 ft



PROJECT:

*BURR JONES  
PARK SITE  
IMPROVEMENTS*

*BURR JONES PARK  
1820 E. WASHINGTON AVE.  
MADISON, WI 53704*

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ITEM	DATE
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Advertised to bid:	05-30-19

PUBLIC WORKS PROJECT #:  
**8359**

SHEET TITLE:  
**SITE PLAN - FIELD  
NORTH**

SHEET NUMBER:  
**5.3**

**LEGEND**


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- G - EX. GAS
- OH - EX. OVERHEAD ELECTRIC LINE
- ☼ EX. LIGHT POLE
- ☼ EX. TREE
- ⊕ EX. HYDRANT
- · - · PRO. PROJECT LIMITS
- ⊕ PRO. ATHLETIC FIELD LIGHT POLE
- PRO. ATHLETIC FIELD EXTENTS

**NOTES**

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2. CONTRACTOR SHALL NOT STORE ANY MATERIALS WITHIN MG&E AND ATC EASEMENTS. CONTRACTOR'S SURVEYOR SHALL LOCATE AND STAKE EASEMENTS PRIOR TO CONSTRUCTION.

PRO. ATHLETIC FIELD LIGHTING SYSTEM, PER BID ITEM 90013.  
SEE SHEET 9.0.

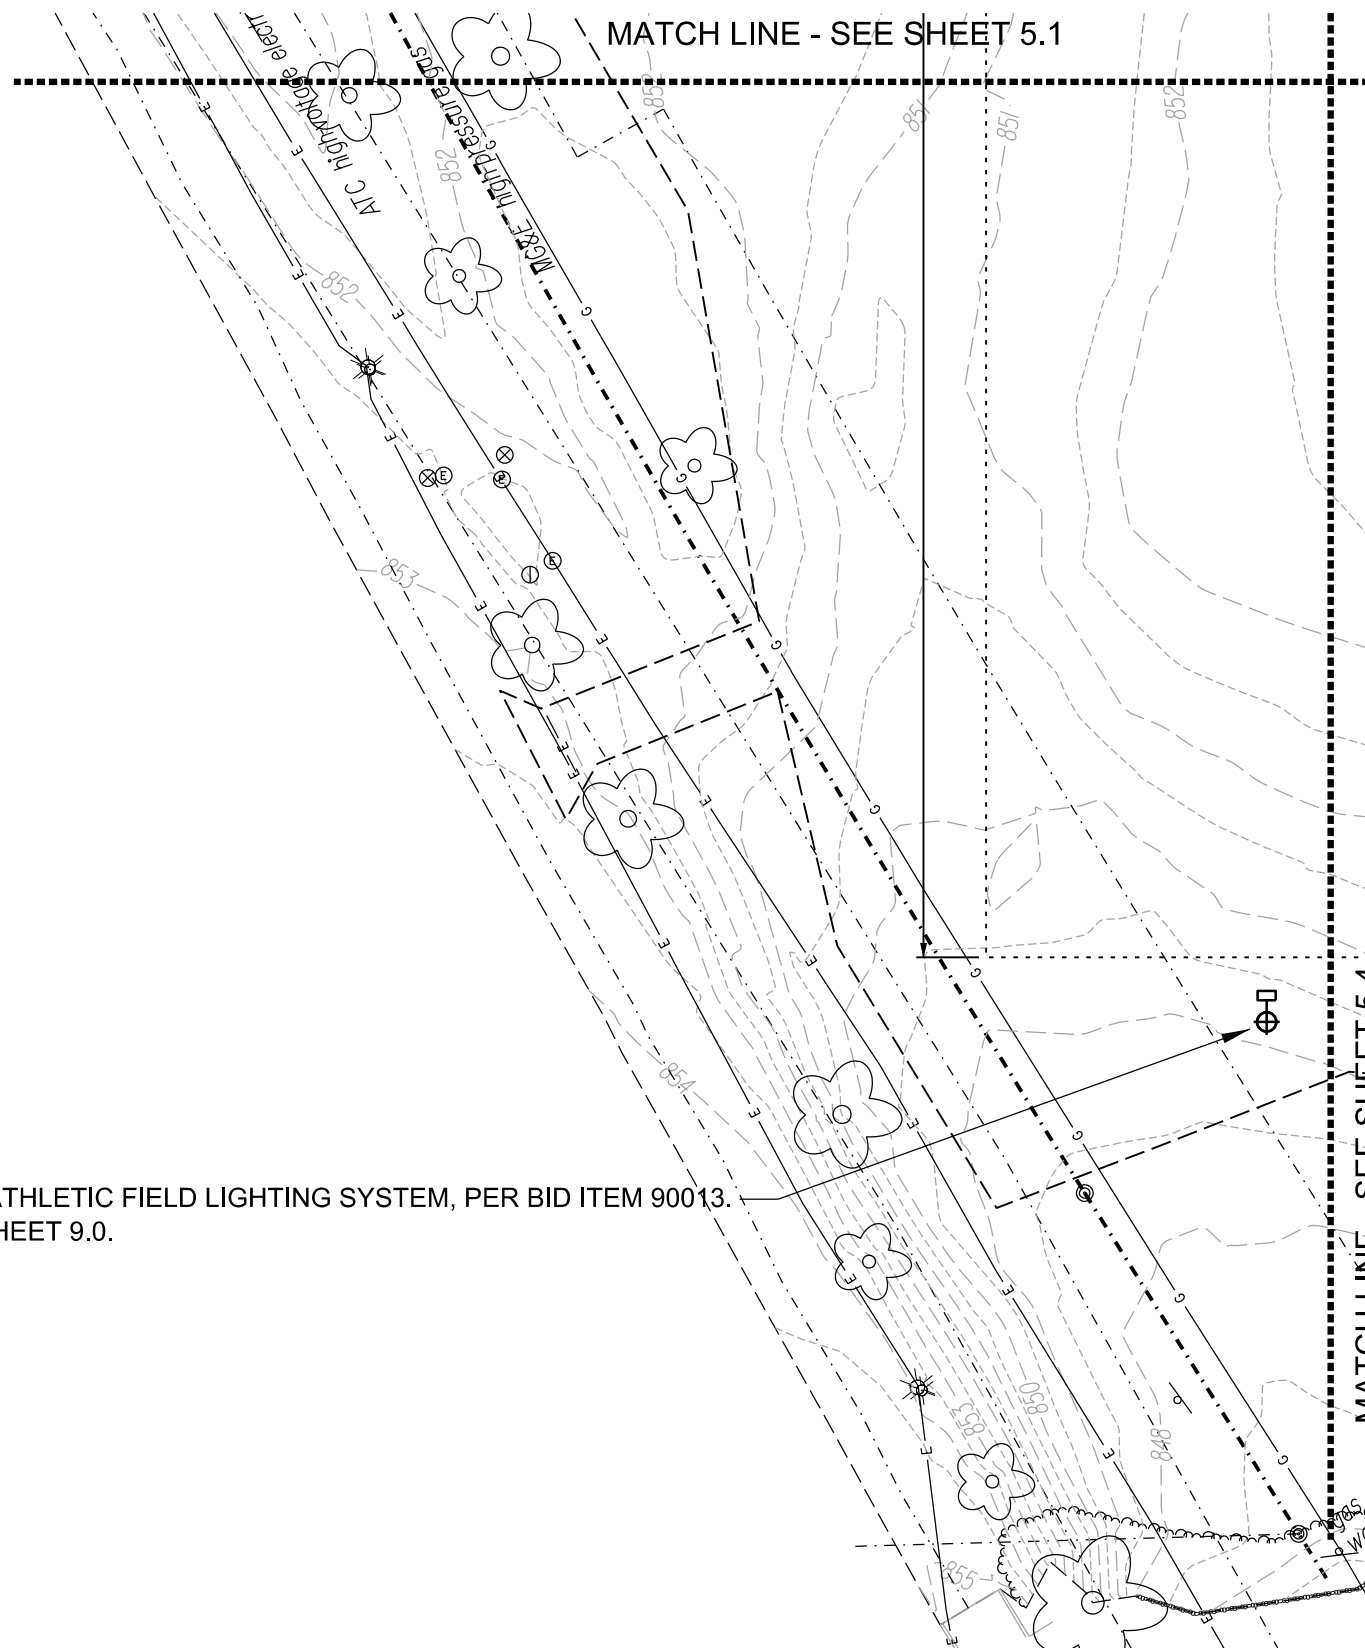

**LEGEND**


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- PRO. ATHLETIC FIELD EXTENTS

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 Madison, WI 53703

*play*  
**MADISON**  
**PARKS**



PROJECT:  
**BURR JONES**  
**PARK SITE**  
**IMPROVEMENTS**

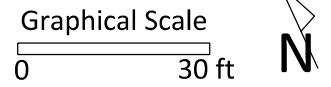**BURR JONES PARK**  
 1820 E. WASHINGTON AVE.  
 MADISON, WI 53704


Although every effort has been made in preparing these plans and checking them for accuracy, the contractor and subcontractors must check all details and dimensions of their trade and be responsible for the same.

ITEM	DATE
Drawing by: MS	05-23-19
Advertised to bid:	05-30-19

PUBLIC WORKS PROJECT #:  
**8359**


SHEET TITLE:  
**SITE PLAN - FIELD**  
**SOUTH**

SHEET NUMBER:  
**5.4**

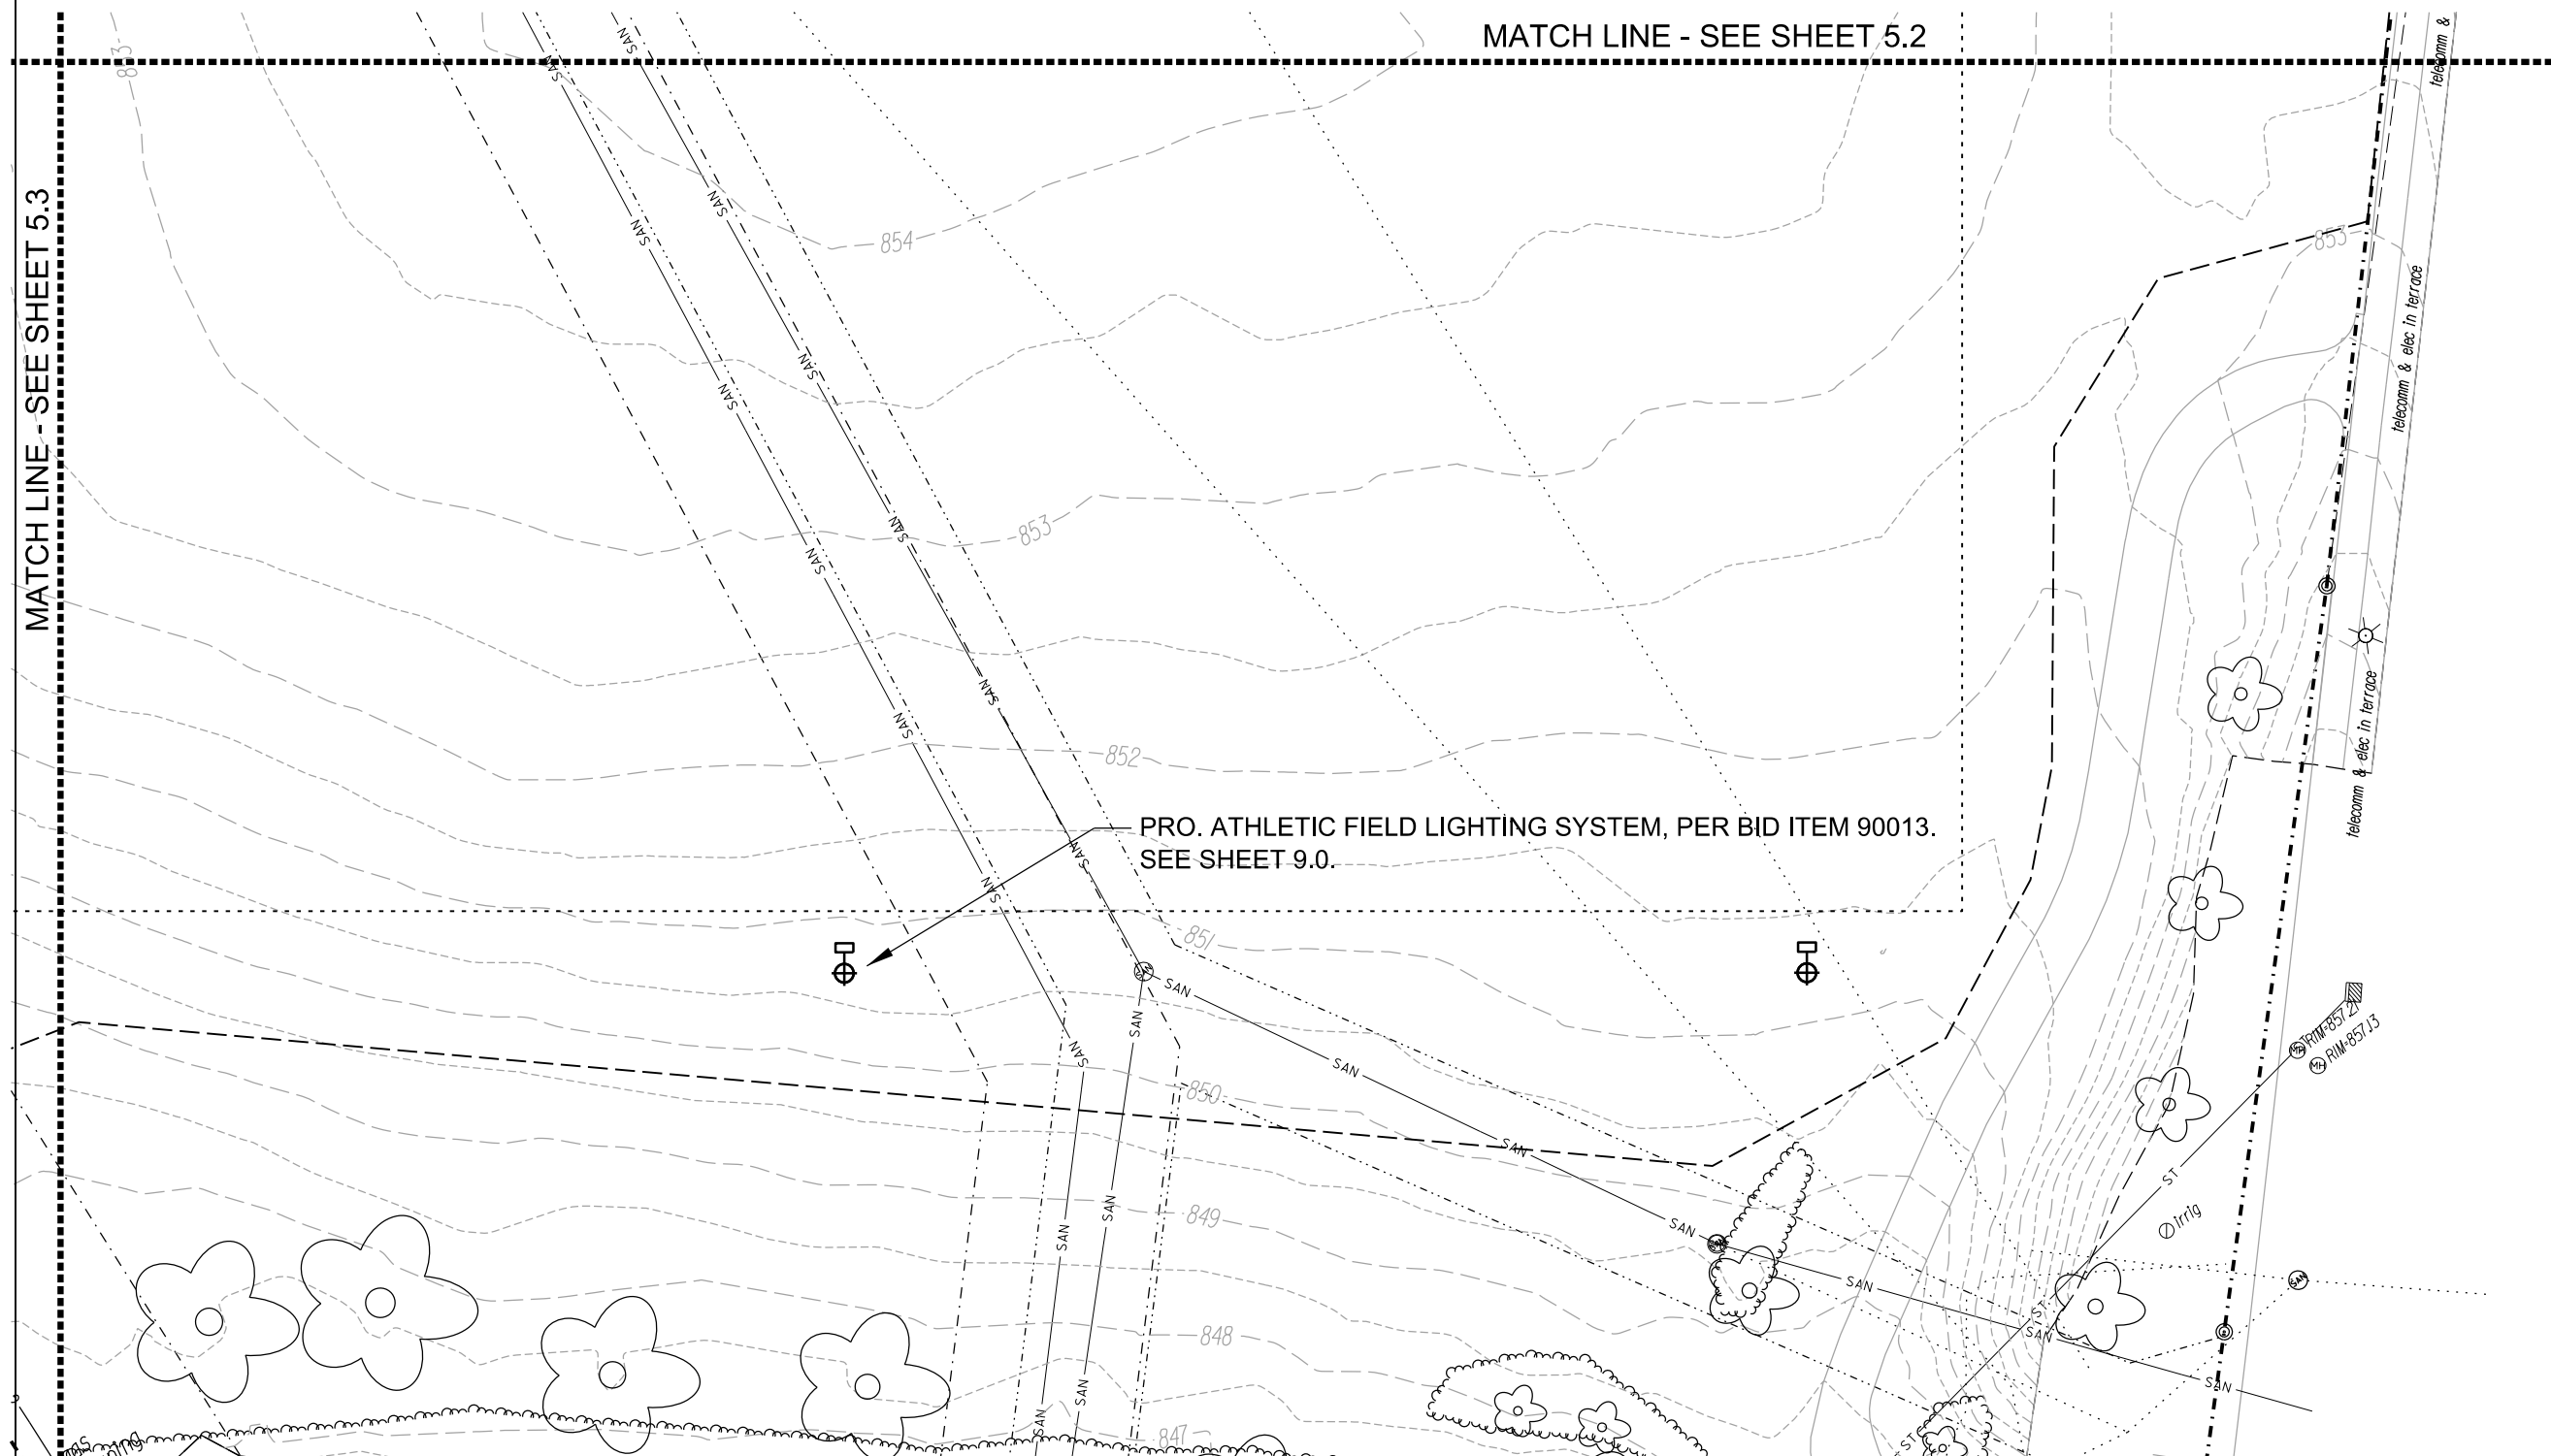

City of Madison  
 Department of Public Works  
**PARKS DIVISION**  
 City-County Building, Suite 104  
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**MADISON  
 PARKS**

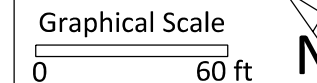

PROJECT:  
**BURR JONES  
 PARK SITE  
 IMPROVEMENTS**

*BURR JONES PARK  
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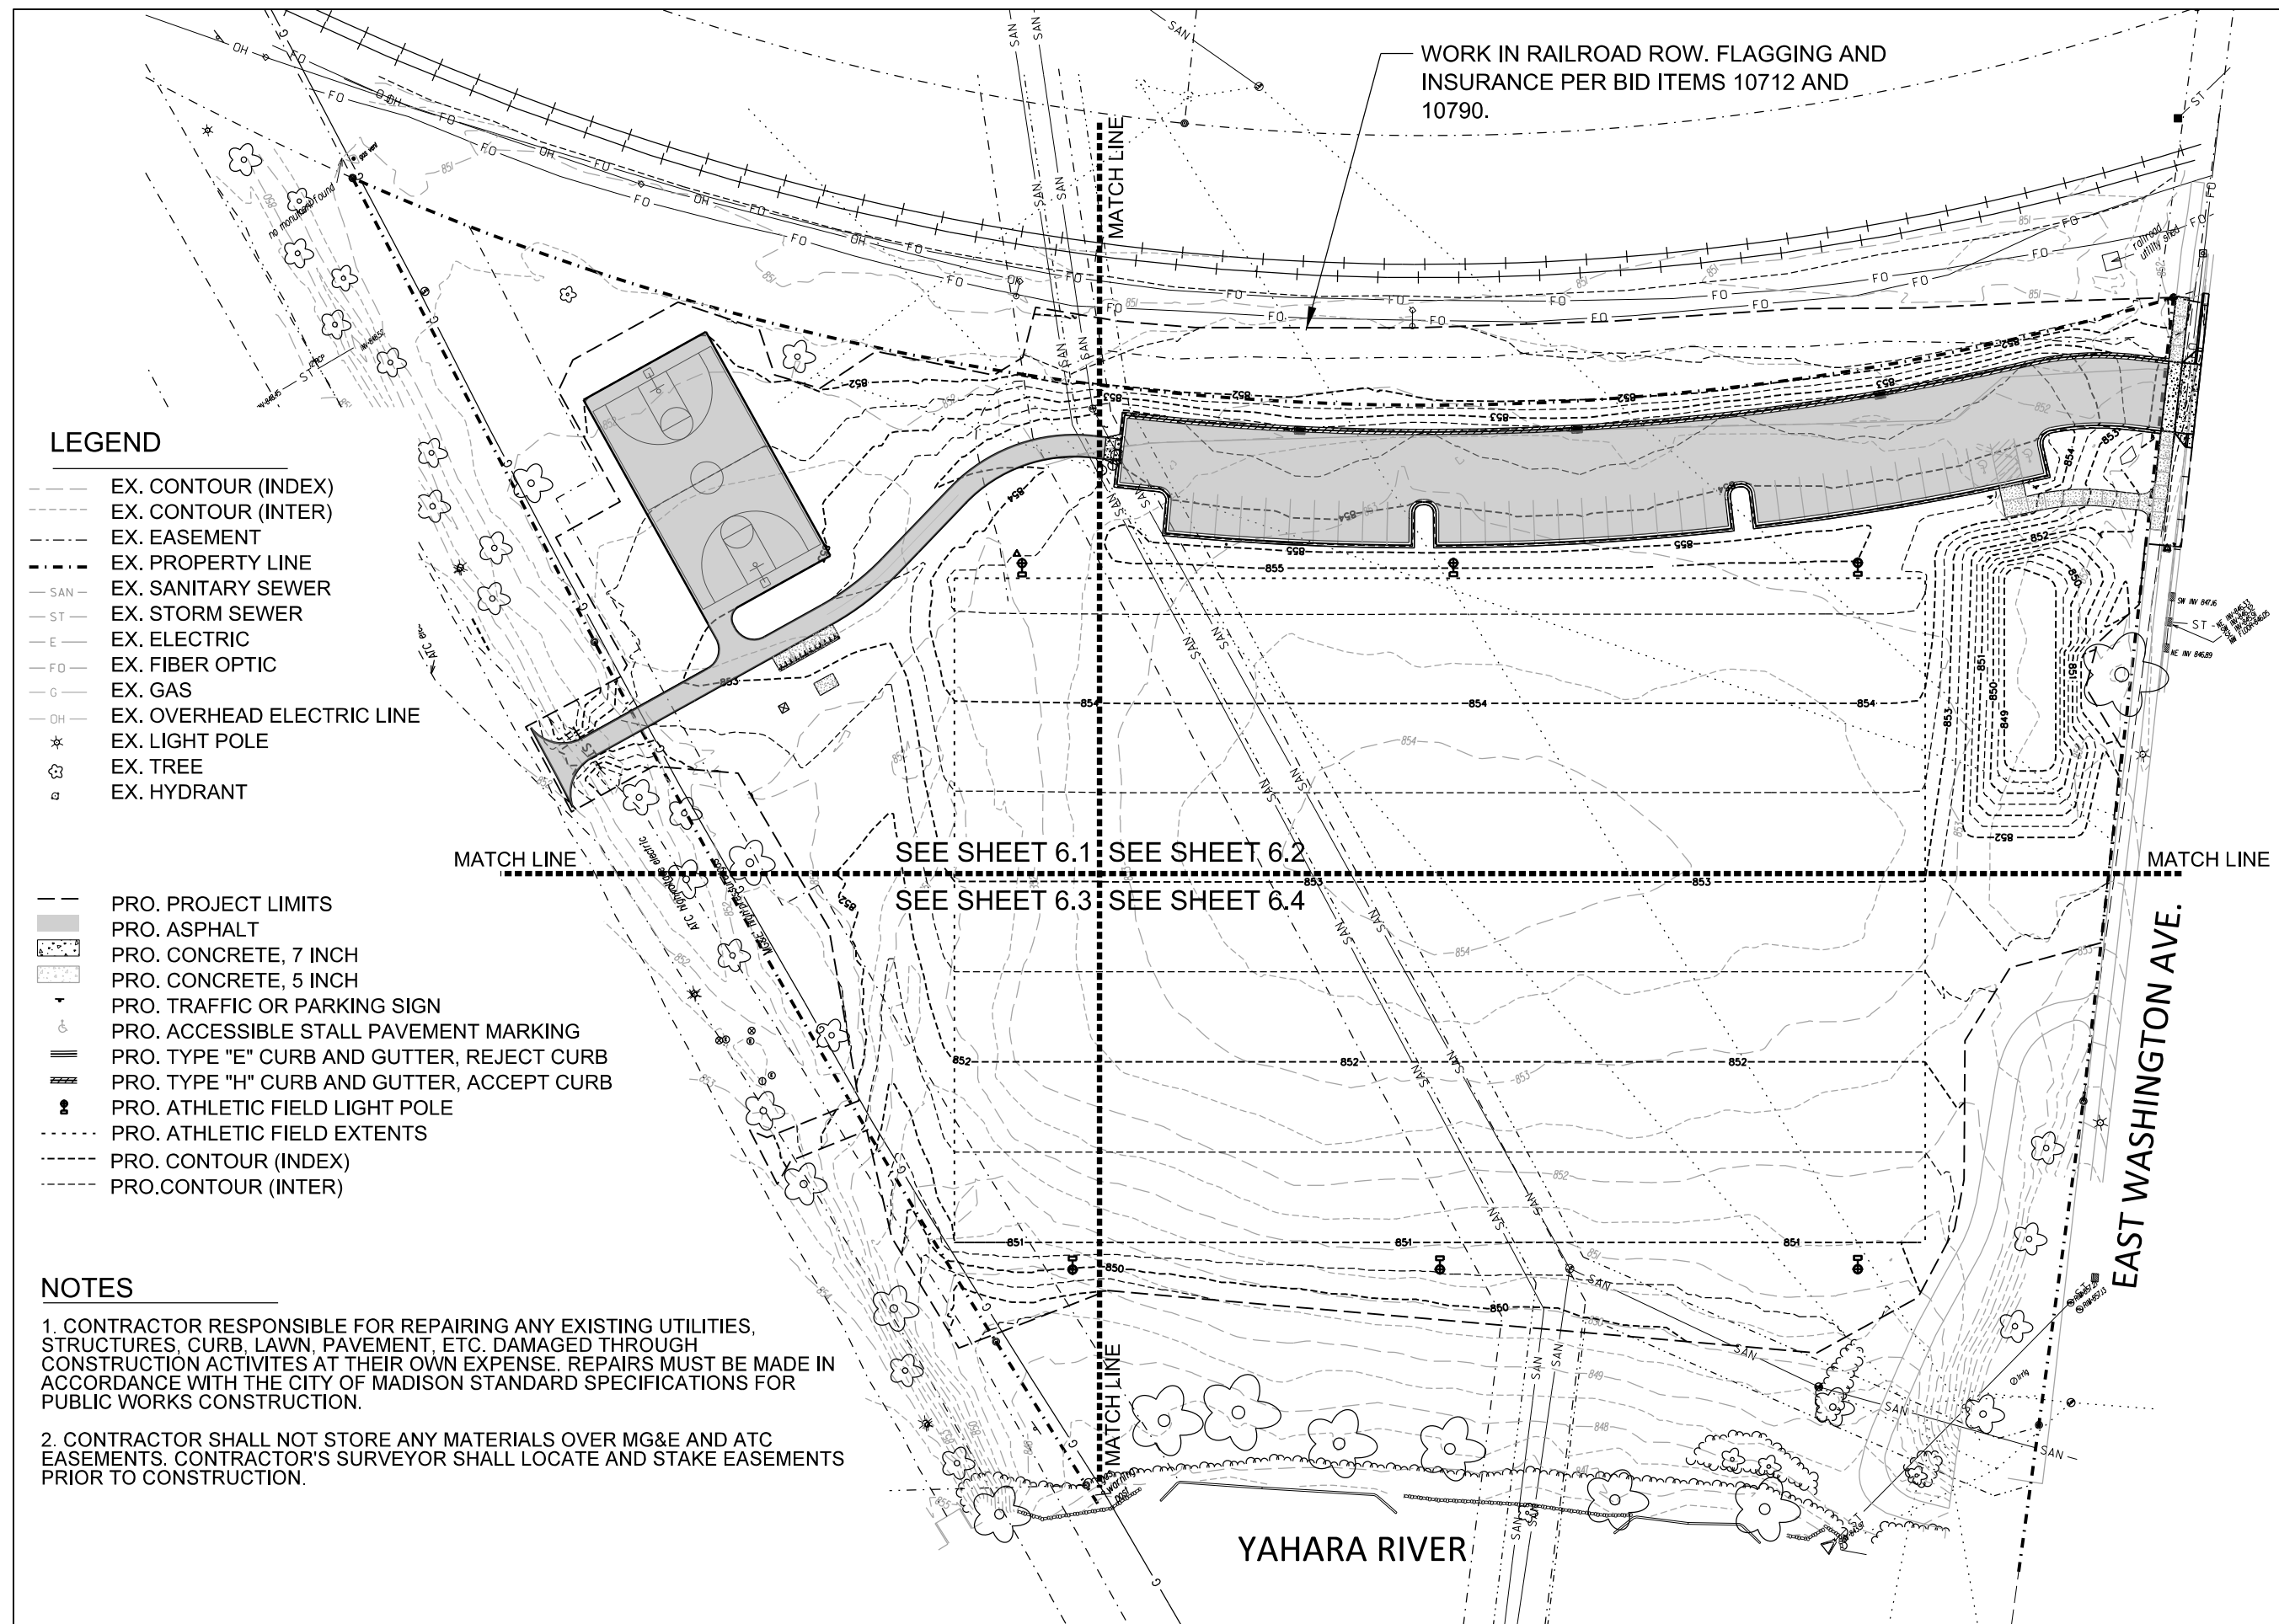
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ITEM	DATE
Drawing by: MS	05-23-19
Advertised to bid:	05-30-19

PUBLIC WORKS PROJECT #:  
**8359**

SHEET TITLE:  
**GRADING PLAN**

SHEET NUMBER:  
**6.0**




**LEGEND**

- EX. CONTOUR (INDEX)
- EX. CONTOUR (INTER)
- EX. EASEMENT
- - - EX. PROPERTY LINE
- SAN - EX. SANITARY SEWER
- ST - EX. STORM SEWER
- E - EX. ELECTRIC
- FO - EX. FIBER OPTIC
- G - EX. GAS
- OH - EX. OVERHEAD ELECTRIC LINE
- \* EX. LIGHT POLE
- ⊗ EX. TREE
- ⊠ EX. HYDRANT

- PRO. PROJECT LIMITS
- ▒ PRO. ASPHALT
- ▒ PRO. CONCRETE, 7 INCH
- ▒ PRO. CONCRETE, 5 INCH
- ▽ PRO. TRAFFIC OR PARKING SIGN
- ⊕ PRO. ACCESSIBLE STALL PAVEMENT MARKING
- ▒ PRO. TYPE "E" CURB AND GUTTER, REJECT CURB
- ▒ PRO. TYPE "H" CURB AND GUTTER, ACCEPT CURB
- ⊙ PRO. ATHLETIC FIELD LIGHT POLE
- PRO. ATHLETIC FIELD EXTENTS
- PRO. CONTOUR (INDEX)
- PRO. CONTOUR (INTER)

**NOTES**

1. CONTRACTOR RESPONSIBLE FOR REPAIRING ANY EXISTING UTILITIES, STRUCTURES, CURB, LAWN, PAVEMENT, ETC. DAMAGED THROUGH CONSTRUCTION ACTIVITIES AT THEIR OWN EXPENSE. REPAIRS MUST BE MADE IN ACCORDANCE WITH THE CITY OF MADISON STANDARD SPECIFICATIONS FOR PUBLIC WORKS CONSTRUCTION.
2. CONTRACTOR SHALL NOT STORE ANY MATERIALS OVER MG&E AND ATC EASEMENTS. CONTRACTOR'S SURVEYOR SHALL LOCATE AND STAKE EASEMENTS PRIOR TO CONSTRUCTION.

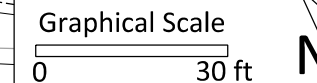

PROJECT:  
**BURR JONES  
 PARK SITE  
 IMPROVEMENTS**

**BURR JONES PARK**  
 1820 E. WASHINGTON AVE.  
 MADISON, WI 53704

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ITEM	DATE
Drawing by: MS	05-23-19
Advised to bid:	05-30-19

PUBLIC WORKS PROJECT #:  
**8359**

SHEET TITLE:  
**GRADING PLAN -  
 BASKETBALL COURT  
 AND PATH**

SHEET NUMBER:  
**6.1**

**LEGEND**


- EX. CONTOUR (INDEX)
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- - - EX. EASEMENT
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- PRO. ATHLETIC FIELD EXTENTS
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3. SEE SHEET 6.5 FOR PATH PROFILE.



**LEGEND**

- EX. CONTOUR (INDEX)
- - - EX. CONTOUR (INTER)
- - - EX. EASEMENT
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- SAN - EX. SANITARY SEWER
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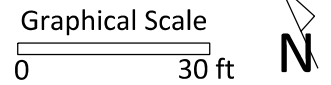
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- ▬▬▬ PRO. TYPE "E" CURB AND GUTTER, REJECT CURB
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- ⊕ PRO. ATHLETIC FIELD LIGHT POLE
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- - - PRO. CONTOUR (INTER)

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**City of Madison**  
 Department of Public Works  
**PARKS DIVISION**  
 City-County Building, Suite 104  
 210 Martin Luther King, Jr. Blvd.  
 Madison, WI 53703

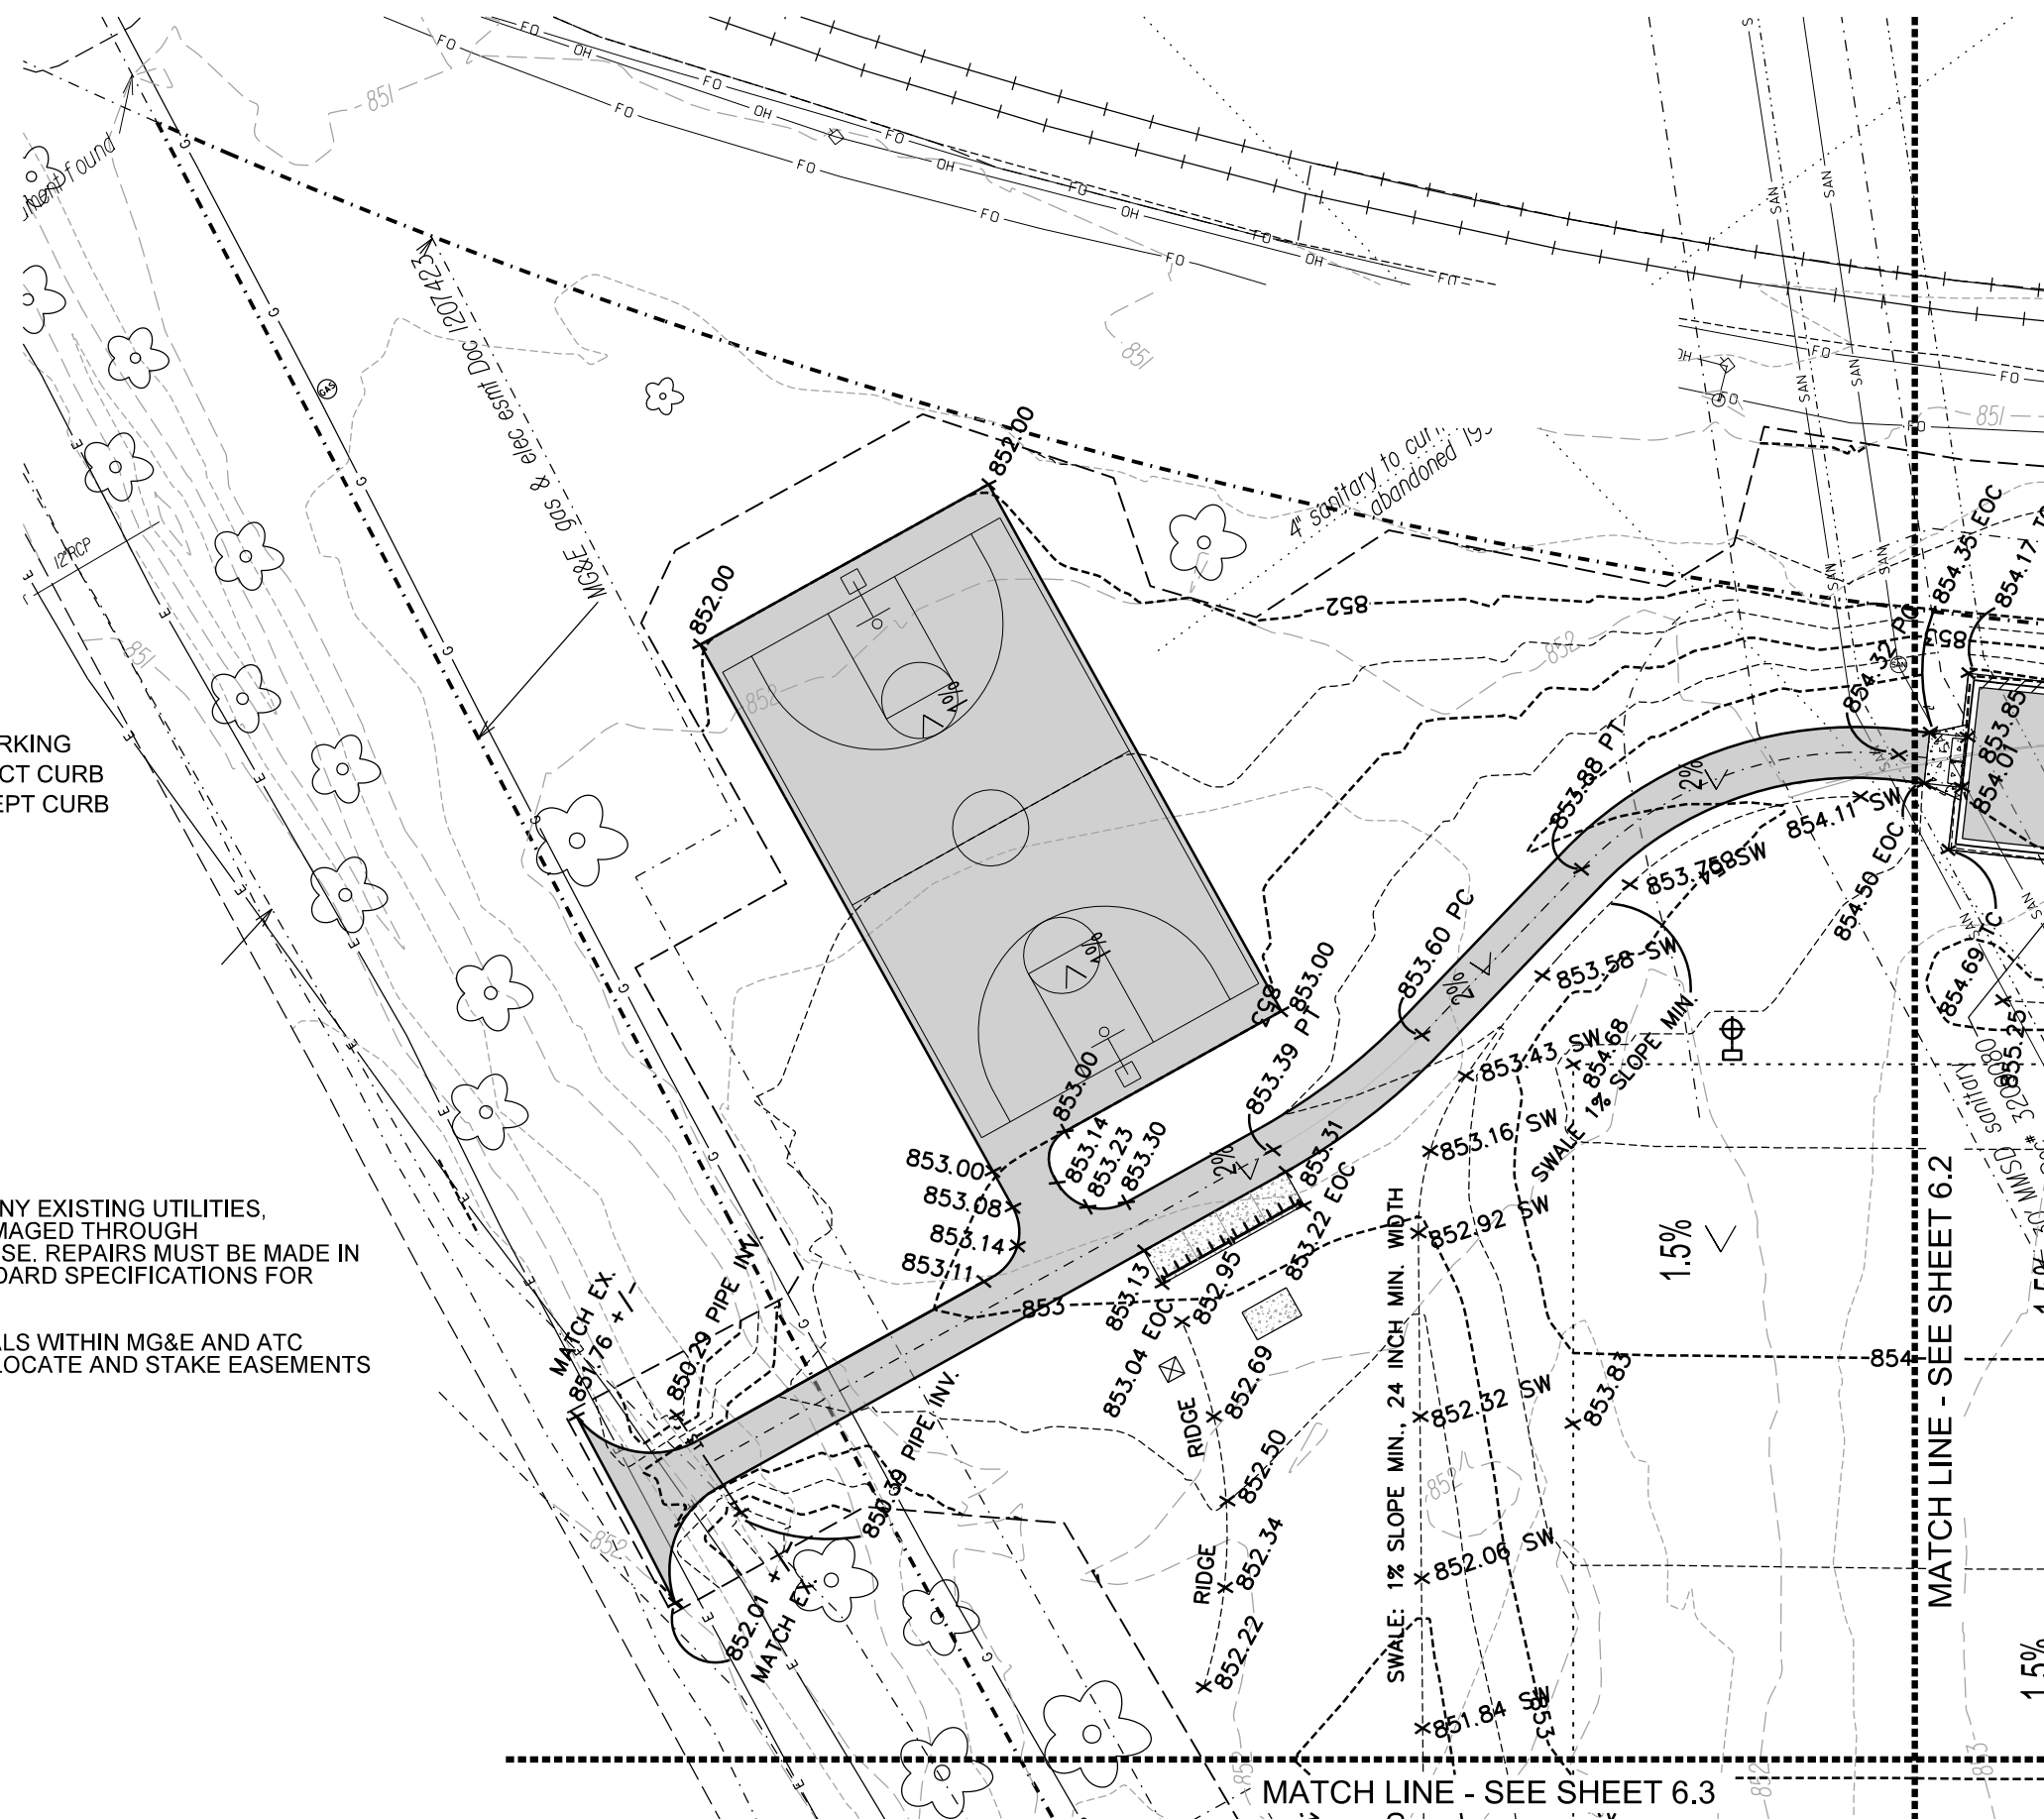*play*  
**MADISON**  
**PARKS**



PROJECT:  
**BURR JONES**  
**PARK SITE**  
**IMPROVEMENTS**

**BURR JONES PARK**  
 1820 E. WASHINGTON AVE.  
 MADISON, WI 53704


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ITEM	DATE
Drawing by: MS	05-23-19
Advertised to bid:	05-30-19

PUBLIC WORKS PROJECT #:  
**8359**

SHEET TITLE:  
**GRADING PLAN -**  
**PARKING LOT**

SHEET NUMBER:  
**6.2**

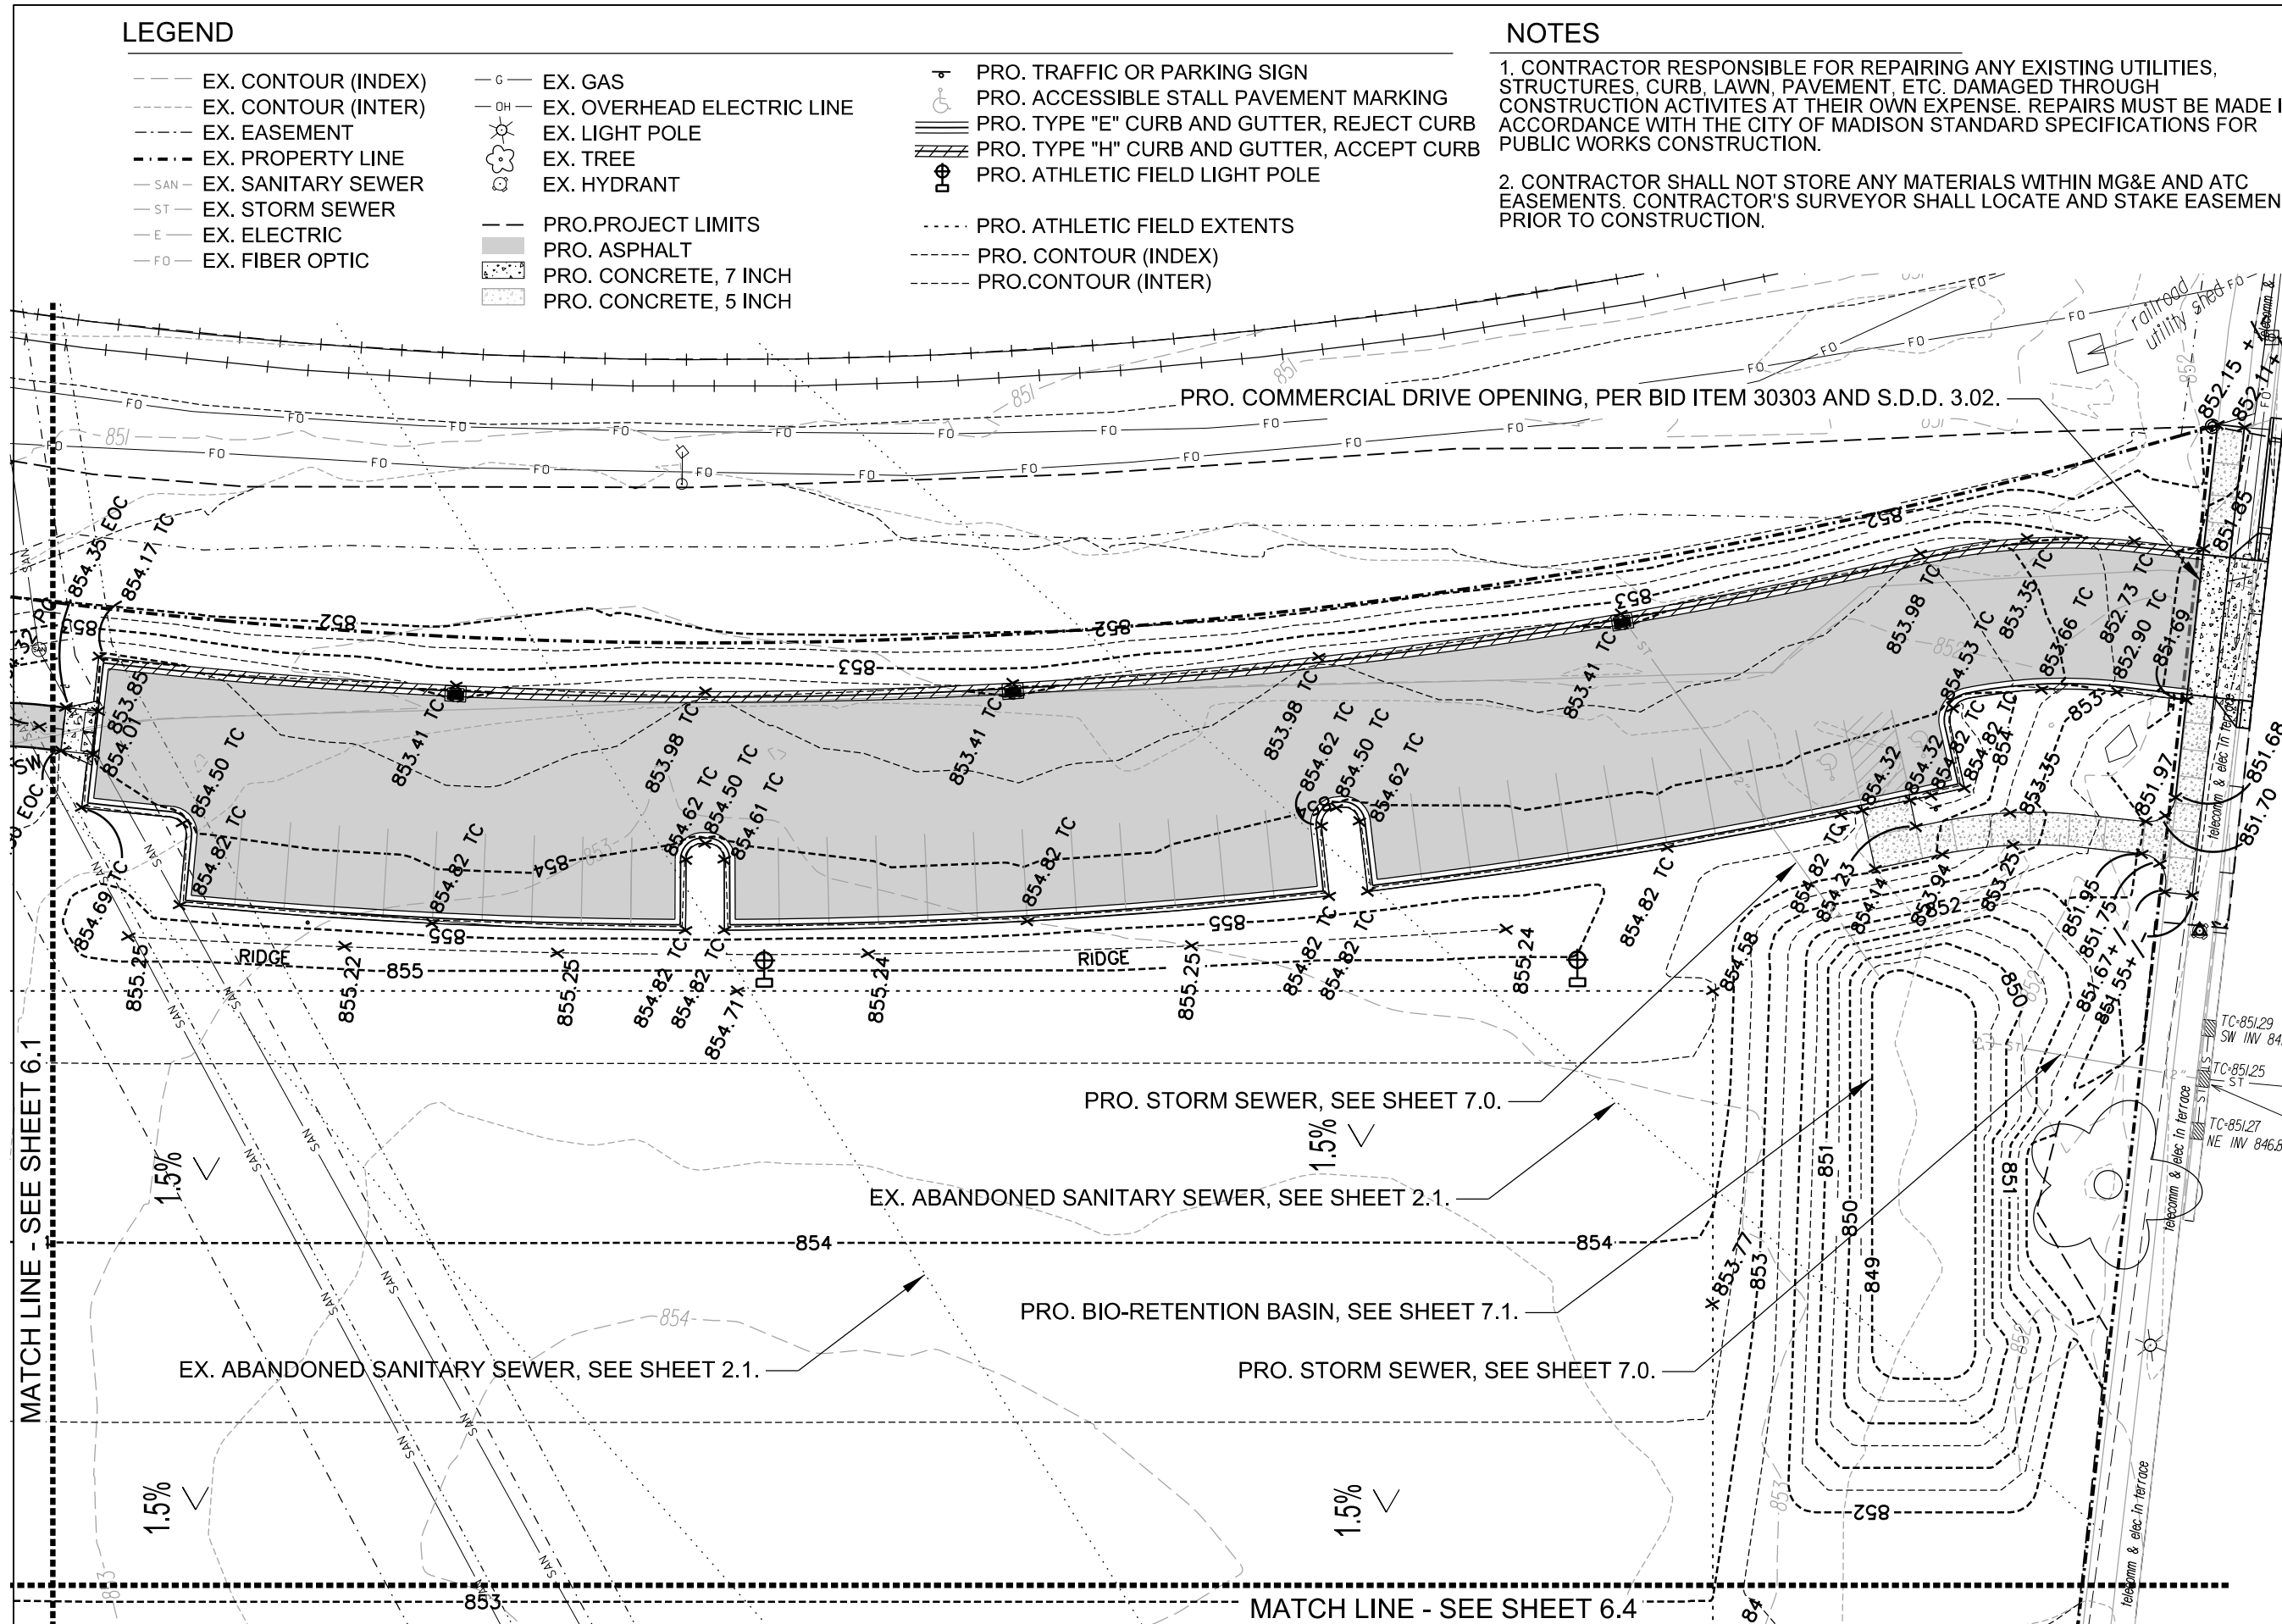

City of Madison  
Department of Public Works  
**PARKS DIVISION**

City-County Building, Suite 104  
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Madison, WI 53703

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**MADISON  
PARKS**

Graphical Scale

0 30 ft



PROJECT:

*BURR JONES  
PARK SITE  
IMPROVEMENTS*

*BURR JONES PARK  
1820 E. WASHINGTON AVE.  
MADISON, WI 53704*

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PUBLIC WORKS PROJECT #:  
**8359**

SHEET TITLE:  
**GRADING PLAN -  
FIELD NORTH**

SHEET NUMBER:

**6.3**


**LEGEND**

- EX. CONTOUR (INDEX)
- - - EX. CONTOUR (INTER)
- - - EX. EASEMENT
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- ☼ EX. LIGHT POLE
- ☼ EX. TREE
- ⊕ EX. HYDRANT
- PRO. PROJECT LIMITS
- ⊕ PRO. ATHLETIC FIELD LIGHT POLE
- ..... PRO. ATHLETIC FIELD EXTENTS
- - - PRO. CONTOUR (INDEX)
- - - PRO. CONTOUR (INTER)

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**LEGEND**


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- - - EX. CONTOUR (INTER)
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- - - EX. PROPERTY LINE
- SAN - EX. SANITARY SEWER
- ST - EX. STORM SEWER
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- ☼ EX. LIGHT POLE
- ☼ EX. TREE
- ⊕ EX. HYDRANT
- PRO. PROJECT LIMITS
- ▒ PRO. ASPHALT
- ▒ PRO. CONCRETE, 7 INCH
- ▒ PRO. CONCRETE, 5 INCH
- ⊕ PRO. ATHLETIC FIELD LIGHT POLE
- - - PRO. ATHLETIC FIELD EXTENTS
- - - PRO. CONTOUR (INDEX)
- - - PRO. CONTOUR (INTER)

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**City of Madison**  
 Department of Public Works  
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 City-County Building, Suite 104  
 210 Martin Luther King, Jr. Blvd.  
 Madison, WI 53703

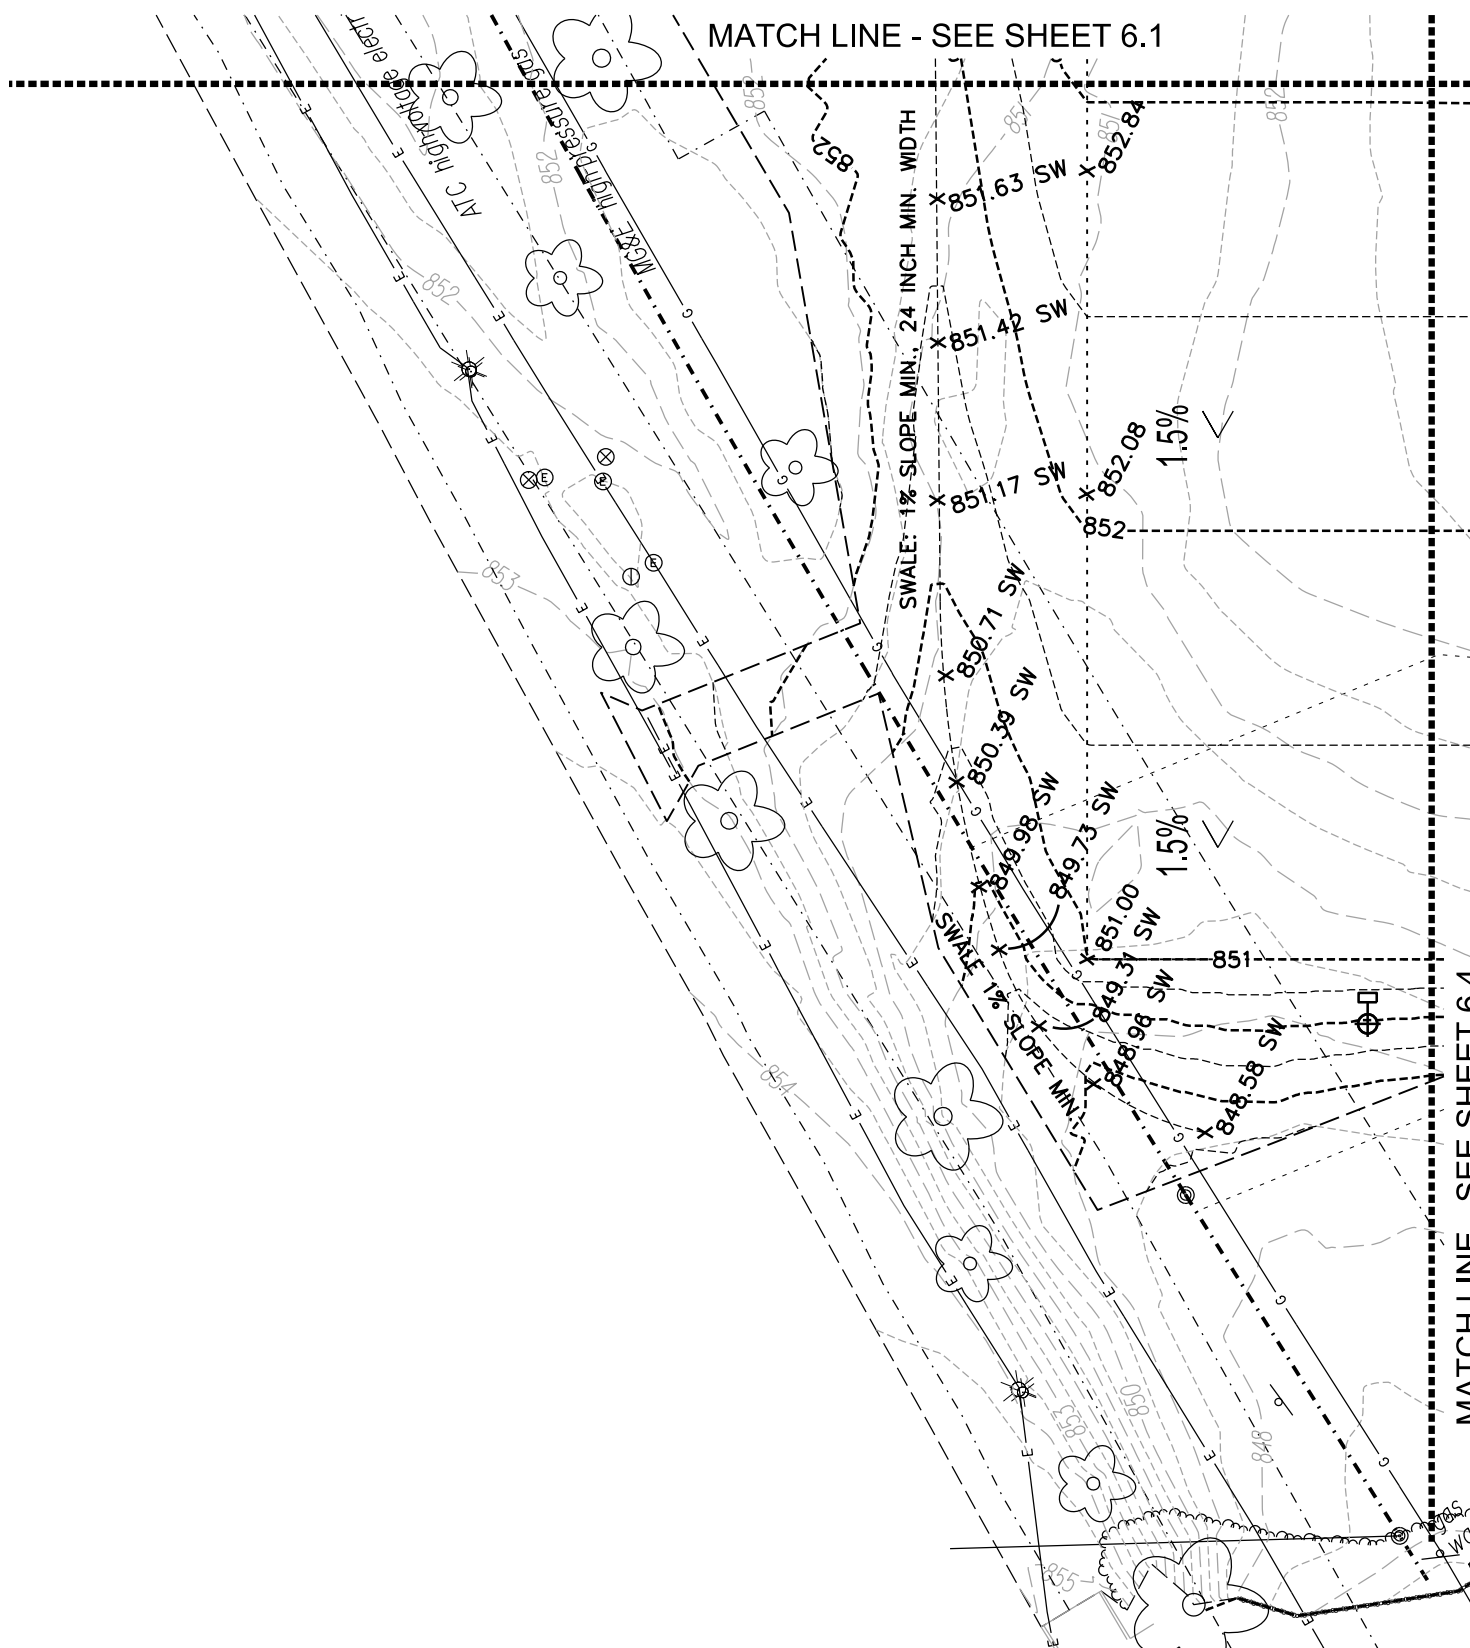*play*  
**MADISON**  
**PARKS**



PROJECT:  
**BURR JONES**  
**PARK SITE**  
**IMPROVEMENTS**

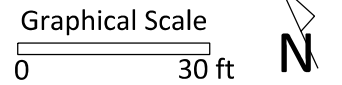**BURR JONES PARK**  
 1820 E. WASHINGTON AVE.  
 MADISON, WI 53704


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ITEM	DATE
Drawing by: MS	05-23-19
Advertised to bid:	05-30-19

PUBLIC WORKS PROJECT #:  
**8359**

SHEET TITLE:  
**GRADING PLAN -**  
**FIELD SOUTH**

SHEET NUMBER:  
**6.4**



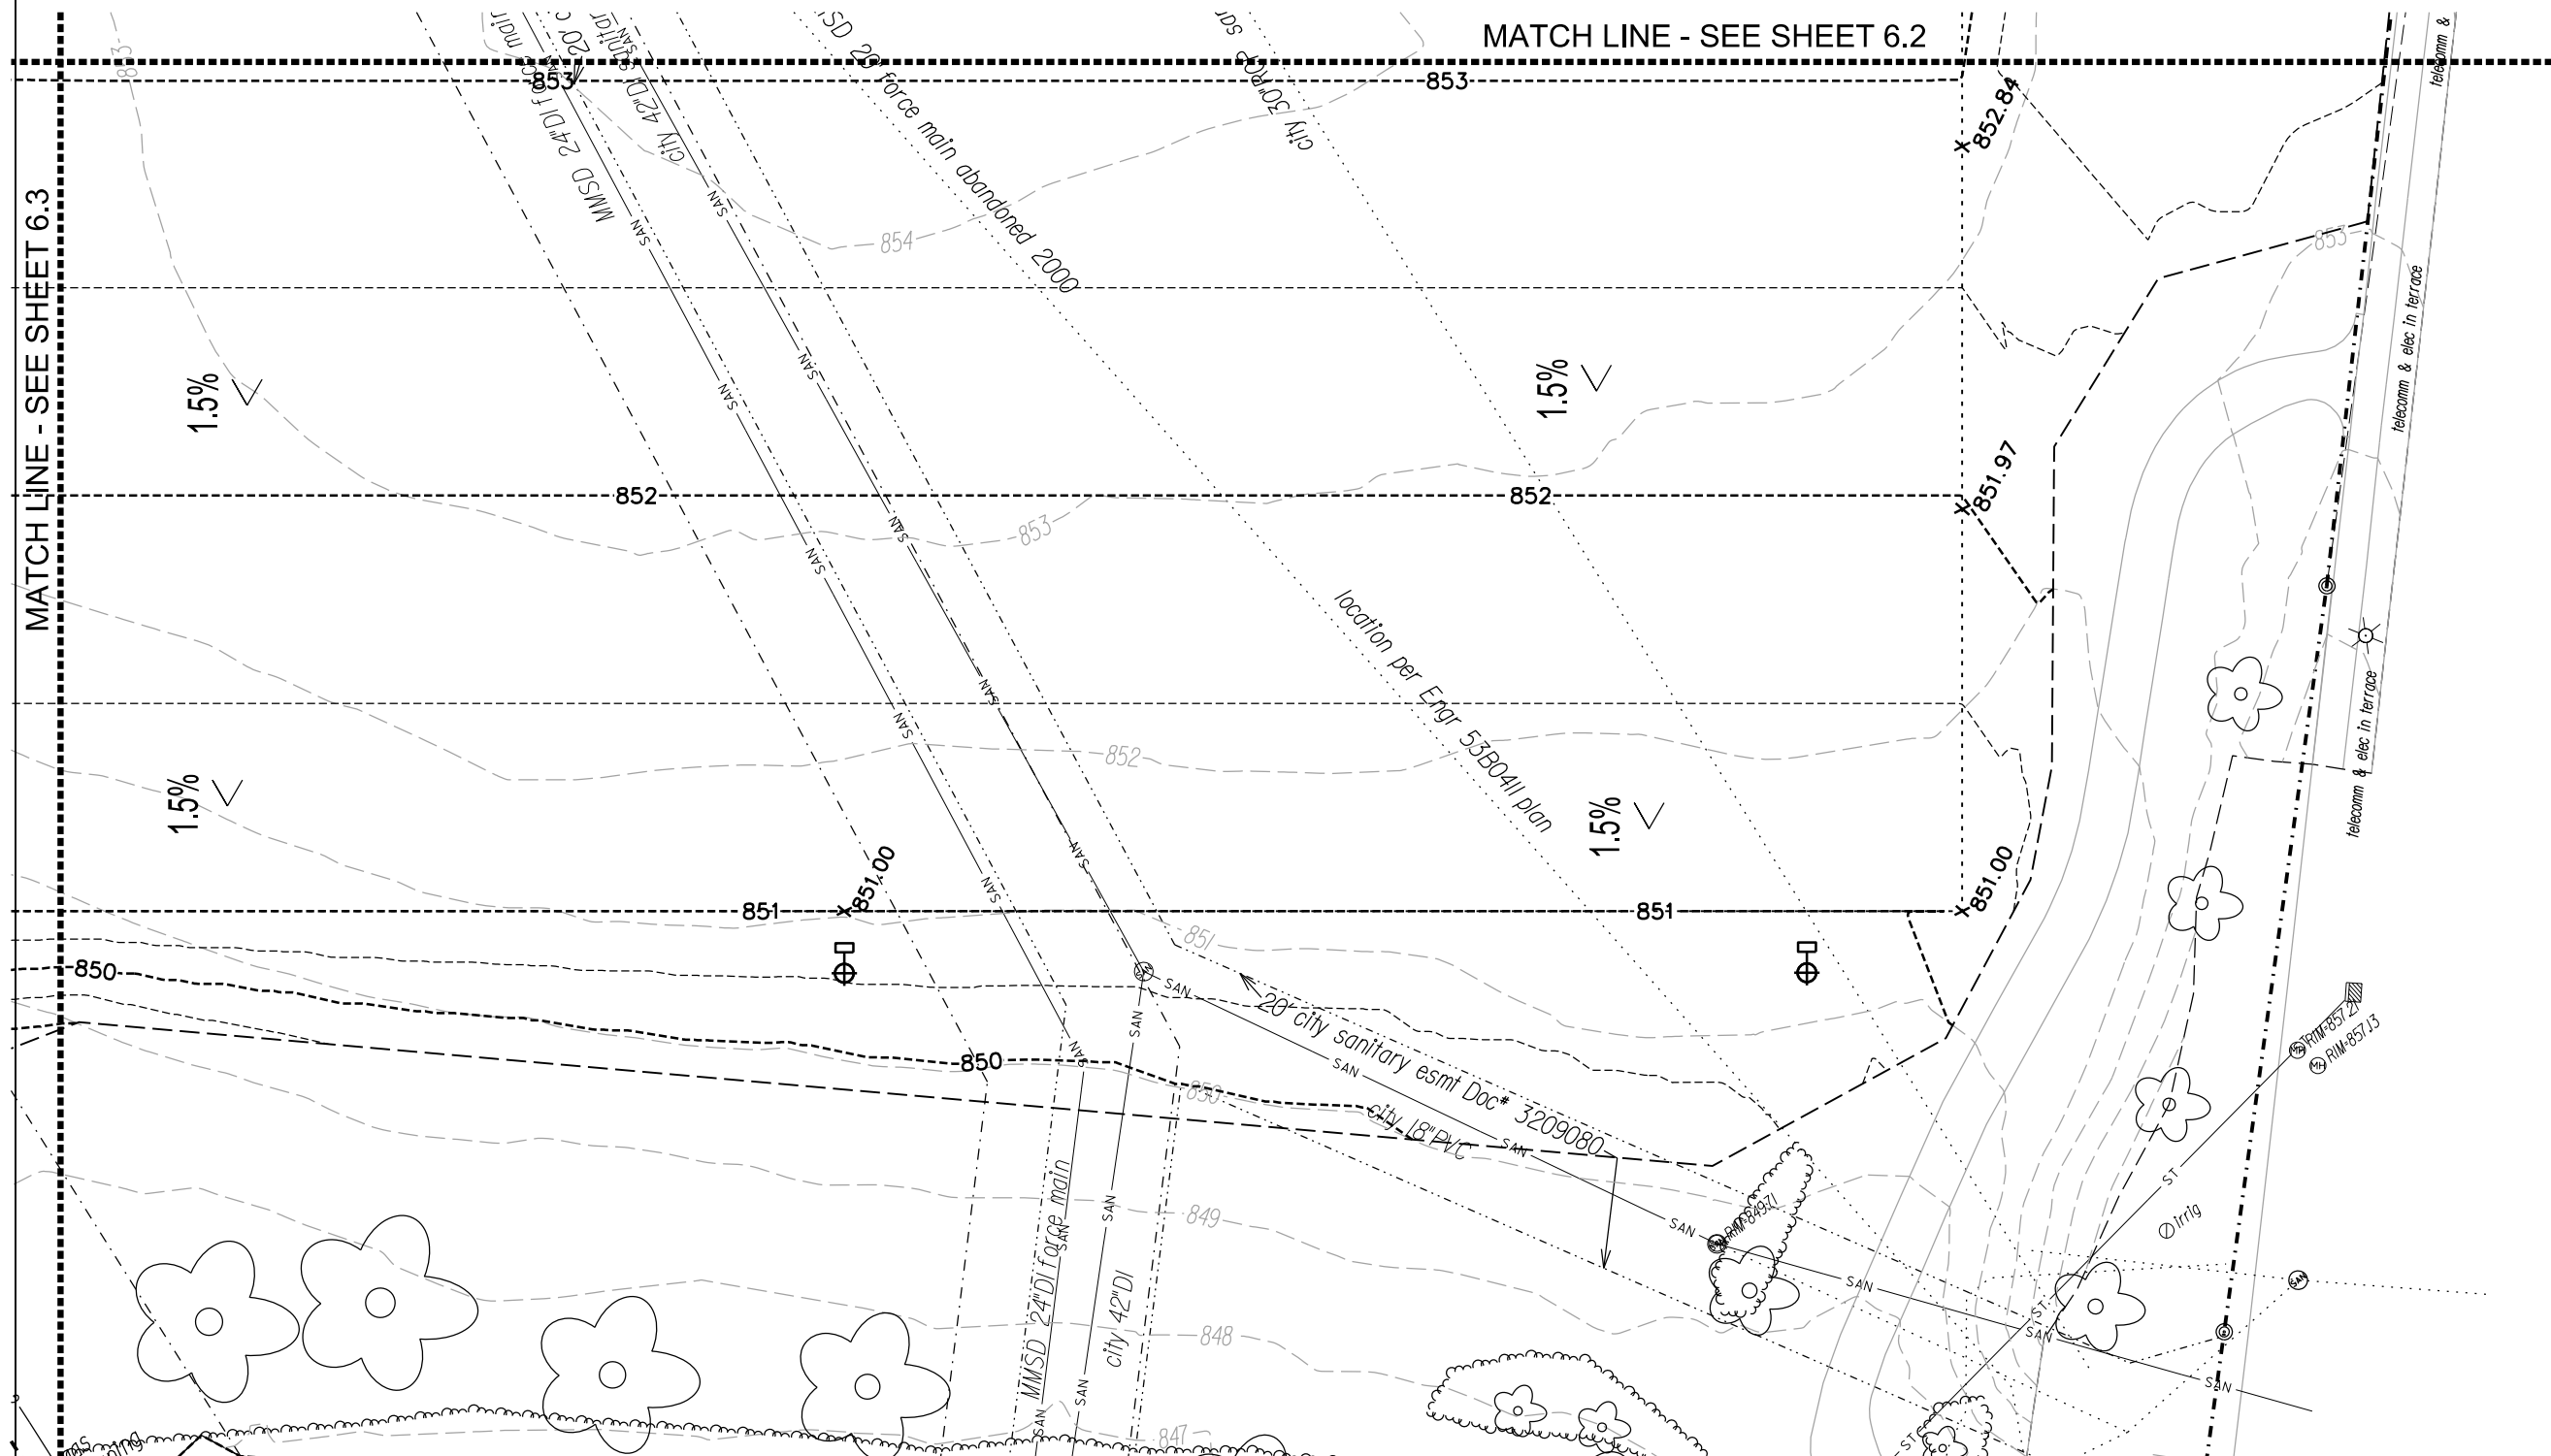



PROJECT:  
**BURR JONES  
 PARK SITE  
 IMPROVEMENTS**

*BURR JONES PARK  
 1820 E. WASHINGTON AVE.  
 MADISON, WI 53704*


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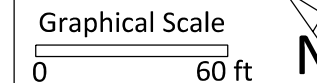
ITEM	DATE
Drawing by: MS	05-23-19
Advertised to bid:	05-30-19

PUBLIC WORKS PROJECT #:  
**8359**

SHEET TITLE:  
**PATH PROFILE**

SHEET NUMBER:  
**6.5**



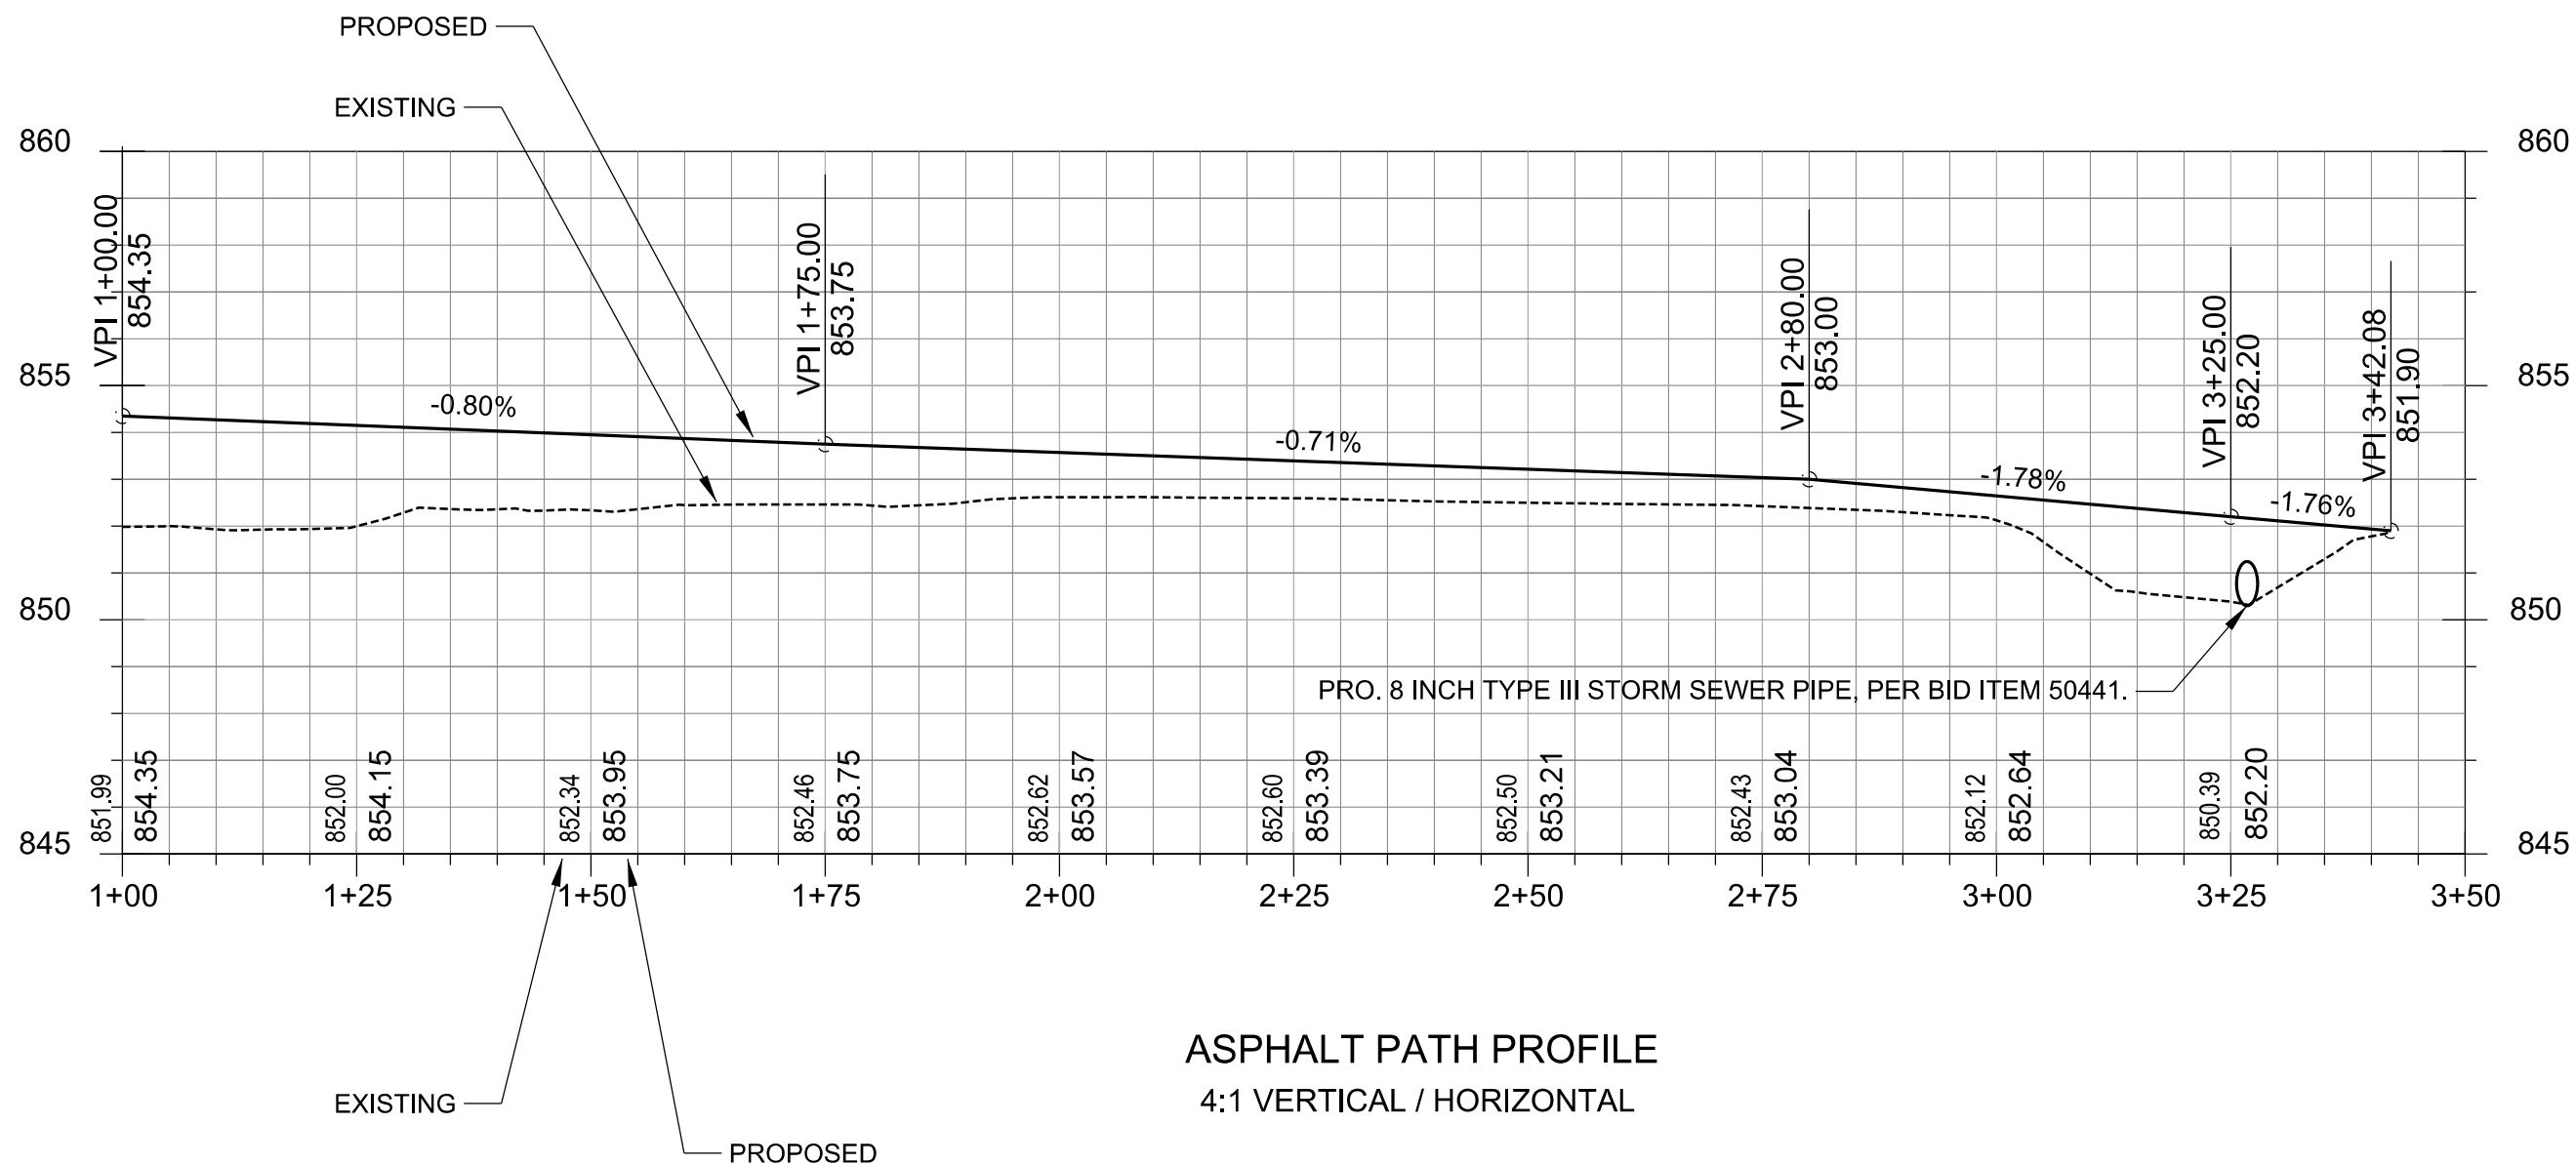

PROJECT:  
**BURR JONES  
 PARK SITE  
 IMPROVEMENTS**

**BURR JONES PARK  
 1820 E. WASHINGTON AVE.  
 MADISON, WI 53704**

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ITEM	DATE
Drawing by: MS	05-23-19
Advised to bid:	05-30-19

PUBLIC WORKS PROJECT #:  
**8359**

SHEET TITLE:  
**ISOPACH PLAN  
 (REFERENCE ONLY)**

SHEET NUMBER:  
**6.6**


**LEGEND**

- - - EX. CONTOUR (INDEX)
- - - EX. CONTOUR (INTER)
- - - EX. EASEMENT
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- EX. HYDRANT

- - - PRO. PROJECT LIMITS
- ▒ PRO. ASPHALT
- ▒ PRO. CONCRETE, 7 INCH
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- ▒▒▒ PRO. TYPE "E" CURB AND GUTTER, REJECT CURB
- ▒▒▒ PRO. TYPE "H" CURB AND GUTTER, ACCEPT CURB
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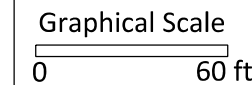
**NOTES**

1. ISOPACH STUDY IS PROVIDED FOR CONTRACTOR GENERAL REFERENCE ONLY - NOT FOR CONSTRUCTION.
2. STUDY IS COMPARISON OF PROPOSED SURFACE ELEVATIONS AND EXISTING SURFACE ELEVATIONS.
3. POSITIVE VALUES INDICATE HIGHER PROPOSED ELEVATION, NEGATIVE VALUES INDICATE LOWER PROPOSED ELEVATION.
4. VALUES ARE IN TENTH-FOOT UNITS.

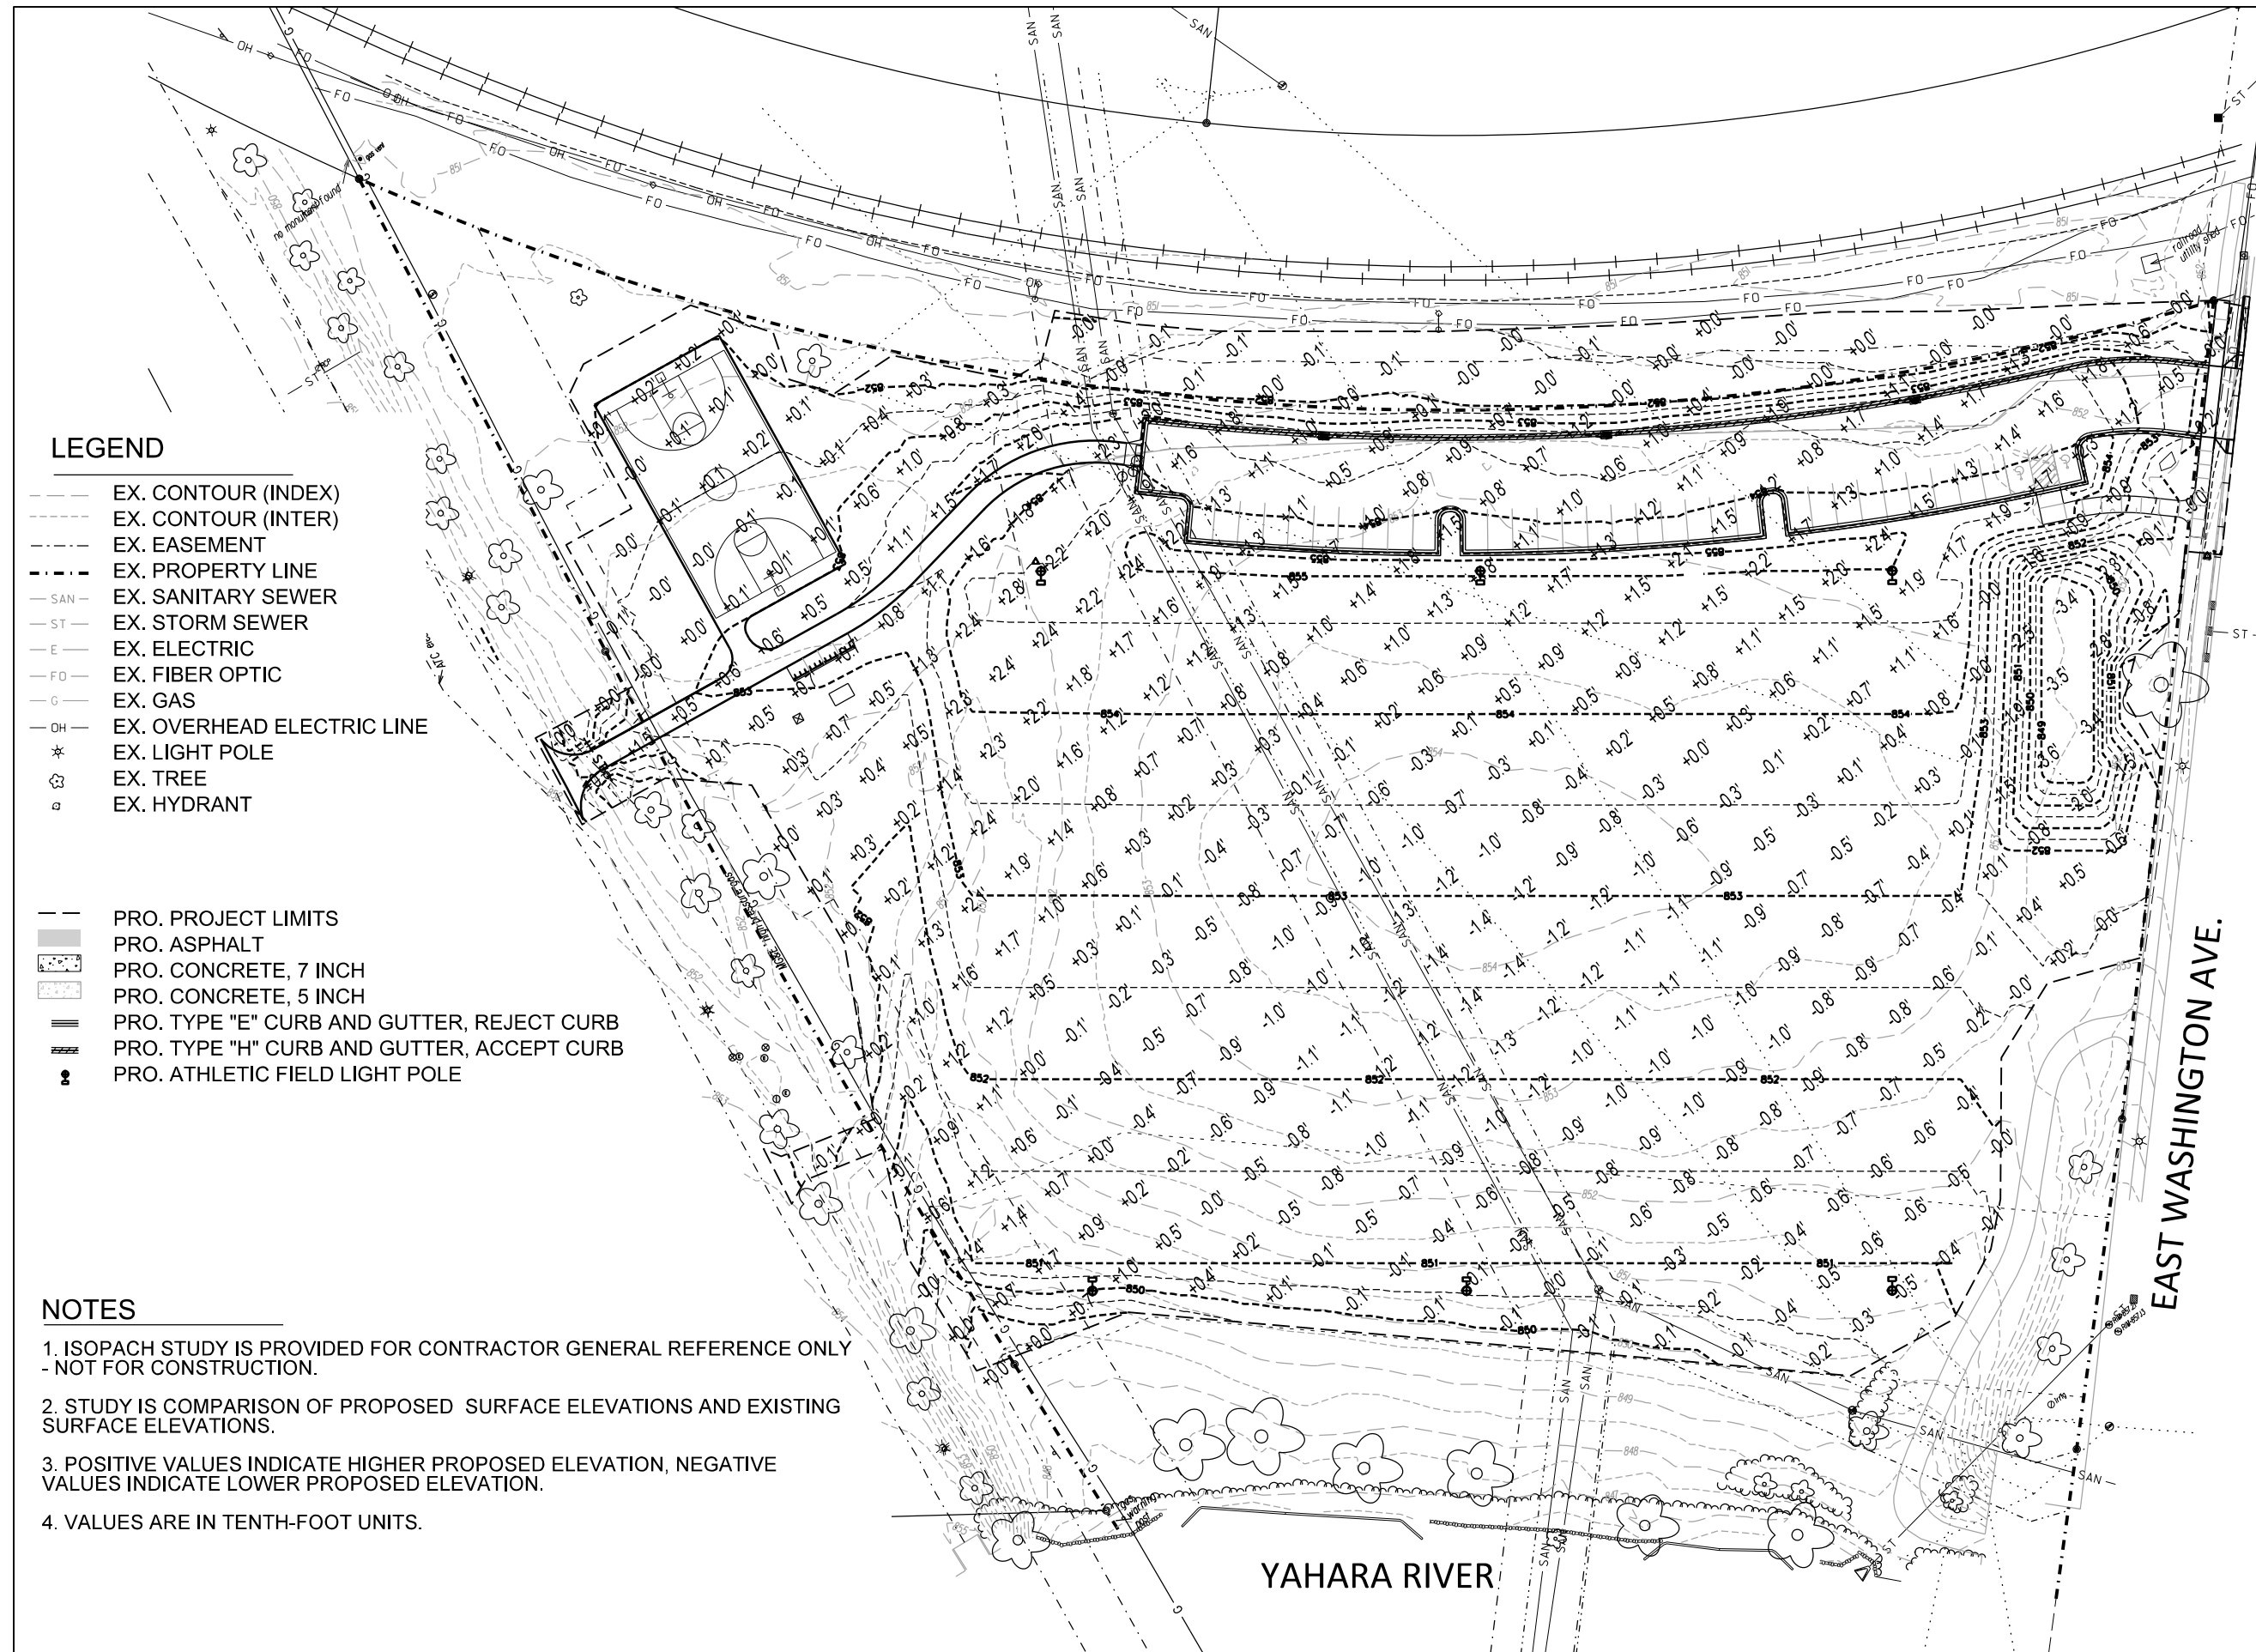

City of Madison  
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PROJECT:

**BURR JONES  
PARK SITE  
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ITEM	DATE
Drawing by: MS	05-23-19
Advised to bid:	05-30-19

PUBLIC WORKS PROJECT #:  
**8359**

SHEET TITLE:  
**GRADING  
COMPUTATIONS**

SHEET NUMBER:  
**6.7**

Burr Jones Park - Earthwork Quantities											
City of Madison, WI Public Works Contract											
Date Revised: 5/16/2019											
<b>Notes:</b>											
Positive volumes are cuts, negative volumes are fills.											
Not all parts of all surface models (Digital Terrain Models) are used for computations or intended for actual construction.											
Existing: Burr Jones Survey 2017-11-13 Comb											
Proposed: Burr Jones Prop 1											

Sort	Grp	Material	Item	From Surface Model	To Surface Model	area (sq ft)	depth (ft)	Unfac-tored volume (cu ft)	Unfac-tored volume (cu yd)	Expans-ion Factor (%)	Factored (Uncom-pacted) Volume (cu yd)	
		Grass to Grass	Topsoil Excavate	Strip 5in topsoil	n/a	n/a	134017	0.42	55751	2064.9	0%	2064.9
		Grass to Grass	Subsoil Excavate	Cut subsoil to proposed subgrade	Ex-5in	Pro-6in	134017	varies	60736	2249.5	0%	2249.5
		Grass to Grass	Subsoil Place	Fill subsoil to proposed subgrade	Ex-5in	Pro-6in	134017	varies	-51511	-1907.8	0%	-1907.8
		Grass to Grass	Topsoil Place	Place 6in topsoil	n/a	n/a	134017	-0.50	-67009	-2481.8	0%	-2481.8
		Asphalt to Grass	Asphalt Excavate	Excavate 12in asphalt	n/a	n/a	22254	1.00	22254	824.2	0%	824.2
		Asphalt to Grass	Subsoil Excavate	Cut subsoil to proposed subgrade	Ex-12in	Pro-6in	22254	varies	0	0.0	0%	0.0
		Asphalt to Grass	Subsoil Place	Fill subsoil to proposed subgrade	Ex-12in	Pro-6in	22254	varies	-21291	-788.6	0%	-788.6
		Asphalt to Grass	Topsoil Place	Place 6in topsoil	n/a	n/a	22254	-0.50	-11127	-412.1	0%	-412.1
		Grass to Asphalt	Topsoil Excavate	Strip 5in topsoil	n/a	n/a	15899	0.42	6614	245.0	0%	245.0
		Grass to Asphalt	Subsoil Excavate	Cut subsoil to proposed subgrade	Ex-5in	Pro-13.5in	15899	varies	1702	63.0	0%	63.0
		Grass to Asphalt	Subsoil Place	Fill subsoil to proposed subgrade	Ex-5in	Pro-13.5in	15899	varies	-5860	-217.0	0%	-217.0
		Grass to Asphalt	Gravel (for Pavement) Place	Place 10in gravel base out to 6in from pavement edge	n/a	n/a	15899	-0.83	-13244	-490.5	0%	-490.5
		Grass to Asphalt	Asphalt Place	Place 3.5in asphalt	n/a	n/a	15899	-0.29	-4611	-170.8	0%	-170.8
		Grass to 5 inch Concrete	Topsoil Excavate	Strip 5in topsoil	n/a	n/a	12	0.42	5	0.2	0%	0.2
		Grass to 5 inch Concrete	Subsoil Excavate	Cut subsoil to proposed subgrade	Ex-5in	Pro-7in	12	varies	0	0.0	0%	0.0
		Grass to 5 inch Concrete	Subsoil Place	Fill subsoil to proposed subgrade	Ex-5in	Pro-7in	12	varies	-4	-0.2	0%	-0.2
		Grass to 5 inch Concrete	Gravel (for Pavement) Place	Place 2in gravel base out to 6in from pavement edge	n/a	n/a	12	-0.17	-2	-0.1	0%	-0.1
		Grass to 5 inch Concrete	Concrete Place	Place 5in concrete	n/a	n/a	12	-0.42	-5	-0.2	0%	-0.2
		Asphalt to Planting Bed	Asphalt Excavate	Excavate 12in asphalt	n/a	n/a	1936	1.00	1936	71.7	0%	71.7
		Asphalt to Planting Bed	Subsoil Excavate	Cut subsoil to proposed subgrade	Ex-12in	Pro-18in	1936	varies	34	1.2	0%	1.2
		Asphalt to Planting Bed	Subsoil Place	Fill subsoil to proposed subgrade	Ex-12in	Pro-18in	1936	varies	-1306	-48.4	0%	-48.4
		Asphalt to Planting Bed	Planting Bed Soil Place	Place 18in topsoil	n/a	n/a	1936	-1.50	-2904	-107.6	0%	-107.6
		Grass to Planting Bed	Topsoil Excavate	Strip 5in topsoil	n/a	n/a	1485	0.42	624	23.1	0%	23.1
		Grass to Planting Bed	Subsoil Excavate	Cut subsoil to proposed subgrade	Ex-5in	Pro-18in	1485	varies	346	12.8	0%	12.8
		Grass to Planting Bed	Subsoil Place	Fill subsoil to proposed subgrade	Ex-5in	Pro-18in	1485	varies	-980	-36.3	0%	-36.3
		Grass to Planting Bed	Planting Bed Soil Place	Place 18in topsoil	n/a	n/a	1485	-1.50	-2228	-82.5	0%	-82.5
		Asphalt to Asphalt	Asphalt Excavate	Excavate 12in asphalt	n/a	n/a	5830	1.00	5830	215.9	0%	215.9
		Asphalt to Asphalt	Subsoil Excavate	Cut subsoil to proposed subgrade	Ex-5in	Pro-13.5in	5830	varies	189	7.0	0%	7.0
		Asphalt to Asphalt	Subsoil Place	Fill subsoil to proposed subgrade	Ex-5in	Pro-13.5in	5830	varies	-3560	-131.9	0%	-131.9
		Asphalt to Asphalt	Gravel (for Pavement) Place	Place 10in gravel base out to 6in from pavement edge	n/a	n/a	5830	-0.83	-4856	-179.9	0%	-179.9
		Asphalt to Asphalt	Asphalt Place	Place 3.5in asphalt	n/a	n/a	5830	-0.29	-1691	-62.6	0%	-62.6
		Asphalt to Curb	Asphalt Excavate	Excavate 12in asphalt	n/a	n/a	967	1.00	967	35.8	0%	35.8
		Asphalt to Curb	Subsoil Excavate	Cut subsoil to proposed subgrade	Ex-12in	Pro-17in	967	varies	5	0.2	0%	0.2
		Asphalt to Curb	Subsoil Place	Fill subsoil to proposed subgrade	Ex-12in	Pro-17in	967	varies	-1089	-40.3	0%	-40.3
		Asphalt to Curb	Gravel (for Pavement) Place	Place 10in gravel base out to 6in from pavement edge	n/a	n/a	967	-0.83	-806	-29.8	0%	-29.8
		Asphalt to Curb	Concrete Place	Place 7in curb	n/a	n/a	967	-0.58	-564	-20.9	0%	-20.9
		Grass to Curb	Asphalt Excavate	Strip 5in topsoil	n/a	n/a	1217	0.42	511	18.9	0%	18.9
		Grass to Curb	Subsoil Excavate	Cut subsoil to proposed subgrade	Ex-5in	Pro-17in	1217	varies	39	1.5	0%	1.5
		Grass to Curb	Subsoil Place	Fill subsoil to proposed subgrade	Ex-5in	Pro-17in	1217	varies	-741	-27.4	0%	-27.4
		Grass to Curb	Gravel (for Pavement) Place	Place 10in gravel base out to 6in from pavement edge	n/a	n/a	1217	-0.83	-1014	-37.5	0%	-37.5
		Grass to Curb	Concrete Place	Place 7in curb	n/a	n/a	1217	-0.58	-710	-26.3	0%	-26.3

		Grass to 7 inch Concrete	Topsoil Excavate	Strip 5in topsoil	n/a	n/a	40	0.42	17	0.6	0%	0.6
		Grass to 7 inch Concrete	Subsoil Excavate	Cut subsoil to proposed subgrade	Ex-5in	Pro-13in	40	varies	0	0.0	0%	0.0
		Grass to 7 inch Concrete	Subsoil Place	Fill subsoil to proposed subgrade	Ex-5in	Pro-13in	40	varies	-66	-2.4	0%	-2.4
		Grass to 7 inch Concrete	Gravel (for Pavement) Place	Place 6in gravel base out to 6in from pavement edge	n/a	n/a	40	-0.50	-20	-0.7	0%	-0.7
		Grass to 7 inch Concrete	Concrete Place	Place 7in concrete	n/a	n/a	40	-0.58	-23	-0.9	0%	-0.9
		5 inch Concrete to 7 inch Concrete	Concrete Excavate	Excavate 7in concrete	n/a	n/a	352	0.58	204	7.6	0%	7.6
		5 inch Concrete to 7 inch Concrete	Subsoil Excavate	Cut subsoil to proposed subgrade	Ex-7in	Pro-13in	352	varies	199	7.4	0%	7.4
		5 inch Concrete to 7 inch Concrete	Subsoil Place	Fill subsoil to proposed subgrade	Ex-7in	Pro-13in	352	varies	0	0.0	0%	0.0
		5 inch Concrete to 7 inch Concrete	Gravel (for Pavement) Place	Place 6in gravel base out to 6in from pavement edge	n/a	n/a	352	-0.50	-176	-6.5	0%	-6.5
		5 inch Concrete to 7 inch Concrete	Concrete Place	Place 7in concrete	n/a	n/a	352	-0.58	-205	-7.6	0%	-7.6
		Asphalt to 5 inch Concrete	Asphalt Excavate	Excavate 12in asphalt	n/a	n/a	201	1.00	201	7.4	0%	7.4
		Asphalt to 5 inch Concrete	Subsoil Excavate	Cut subsoil to proposed subgrade	Ex-5in	Pro-7in	201	varies	0	0.0	0%	0.0
		Asphalt to 5 inch Concrete	Subsoil Place	Fill subsoil to proposed subgrade	Ex-5in	Pro-7in	201	varies	-224	-8.3	0%	-8.3
		Asphalt to 5 inch Concrete	Gravel (for Pavement) Place	Place 2in gravel base out to 6in from pavement edge	n/a	n/a	201	-0.17	-34	-1.2	0%	-1.2
		Asphalt to 5 inch Concrete	Concrete Place	Place 5in concrete	n/a	n/a	201	-0.42	-84	-3.1	0%	-3.1
		Bio-Retention Engineer Soil	Subsoil Excavate	Excavate 24in of subsoil	n/a	n/a	1370	1.00	1370	50.7	0%	50.7
		Bio-Retention Engineer Soil	Engineered Soil Place	Place 24in of Engineered Soil	n/a	n/a	-1370	1.00	-1370	-50.7	0%	-50.7

**Burr Jones Park - Earthwork Quantities**

City of Madison, WI Public Works Contract

Date Revised: 5/22/2019

Derived from more detailed spreadsheet available from Parks Div.

**Computation Summary**

Positive volumes are cuts (material available), negative volumes are fills (material needed)

**Row Labels**      **Sum of Unfac-tored volume (cu yd)**

Asphalt Place	-233.4
Gravel (for Pavement) Place	-746.3
Subsoil Excavate	2393.3
Subsoil Place	-3208.6
Topsoil Excavate	2333.7
Topsoil Place	-2893.9
Asphalt Excavate	1174.0
Planting Bed Soil Place	-190.1
Concrete Place	-59.0
Concrete Excavate	7.6
Engineered Soil Place	-50.7
<b>Grand Total</b>	<b>-1473.3</b>

Bid Item	Quantity	Units	Relation to Table Above
20101 Excavation Cut	5901	CY	=Subsoil Excavate + Topsoil Excavate + Asphalt Excavate
20201 Fill	815	CY	= Subsoil Excavate - Subsoil Place
20221 Topsoil	17329	SY	= Topsoil Place/.167 (depth)
40102 Crushed Aggregate Base Course Gradation No. 2 & 3	1492.7	TONS	= (Gravel Place) * 2.0 ton/cubic yard
40202 HMA PAVEMENT 4 LT 58-28 S	504.1	TONS	= Asphalt Place * 2.16 ton/cubic yard

**LEGEND**

- EX. EASEMENT
- - - EX. PROPERTY LINE
- SAN - EX. SANITARY SEWER
- ST - EX. STORM SEWER
- E - EX. ELECTRIC
- FO - EX. FIBER OPTIC
- G - EX. GAS
- OH - EX. OVERHEAD ELECTRIC LINE
- ☀ - EX. LIGHT POLE
- 🌳 - EX. TREE
- 🚒 - EX. HYDRANT
- PRO. PROJECT LIMITS
- - - PRO. CONTOUR (INDEX)
- - - PRO. CONTOUR (INTER)


- 🚦 PRO. TRAFFIC OR PARKING SIGN
- ♿ PRO. ACCESSIBLE STALL PAVEMENT MARKING
- ▨ PRO. TYPE "E" CURB AND GUTTER, REJECT CURB
- ▨ PRO. TYPE "H" CURB AND GUTTER, ACCEPT CURB
- 🏠 PRO. ATHLETIC FIELD LIGHT POLE

**NOTES**

1. CONTRACTOR RESPONSIBLE FOR REPAIRING ANY EXISTING UTILITIES, STRUCTURES, CURB, LAWN, PAVEMENT, ETC. DAMAGED THROUGH CONSTRUCTION ACTIVITIES AT THEIR OWN EXPENSE. REPAIRS MUST BE MADE IN ACCORDANCE WITH THE CITY OF MADISON STANDARD SPECIFICATIONS FOR PUBLIC WORKS CONSTRUCTION.
2. CONTRACTOR SHALL NOT STORE ANY MATERIALS WITHIN MG&E AND ATC EASEMENTS. CONTRACTOR'S SURVEYOR SHALL LOCATE AND STAKE EASEMENTS PRIOR TO CONSTRUCTION.

**City of Madison**  
 Department of Public Works  
**PARKS DIVISION**  
 City-County Building, Suite 104  
 210 Martin Luther King, Jr. Blvd.  
 Madison, WI 53703

*play*  
**MADISON**  
**PARKS**

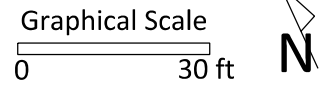

PROJECT:  
**BURR JONES**  
**PARK SITE**  
**IMPROVEMENTS**

**BURR JONES PARK**  
 1820 E. WASHINGTON AVE.  
 MADISON, WI 53704


Although every effort has been made in preparing these plans and checking them for accuracy, the contractor and subcontractors must check all details and dimensions of their trade and be responsible for the same.

ITEM	DATE
Drawing by: MS	05-23-19
Advised to bid:	05-30-19

PUBLIC WORKS PROJECT #:  
**8359**

SHEET TITLE:  
**UTILITY PLAN -**  
**STORM SEWER**

SHEET NUMBER:  
**7.0**

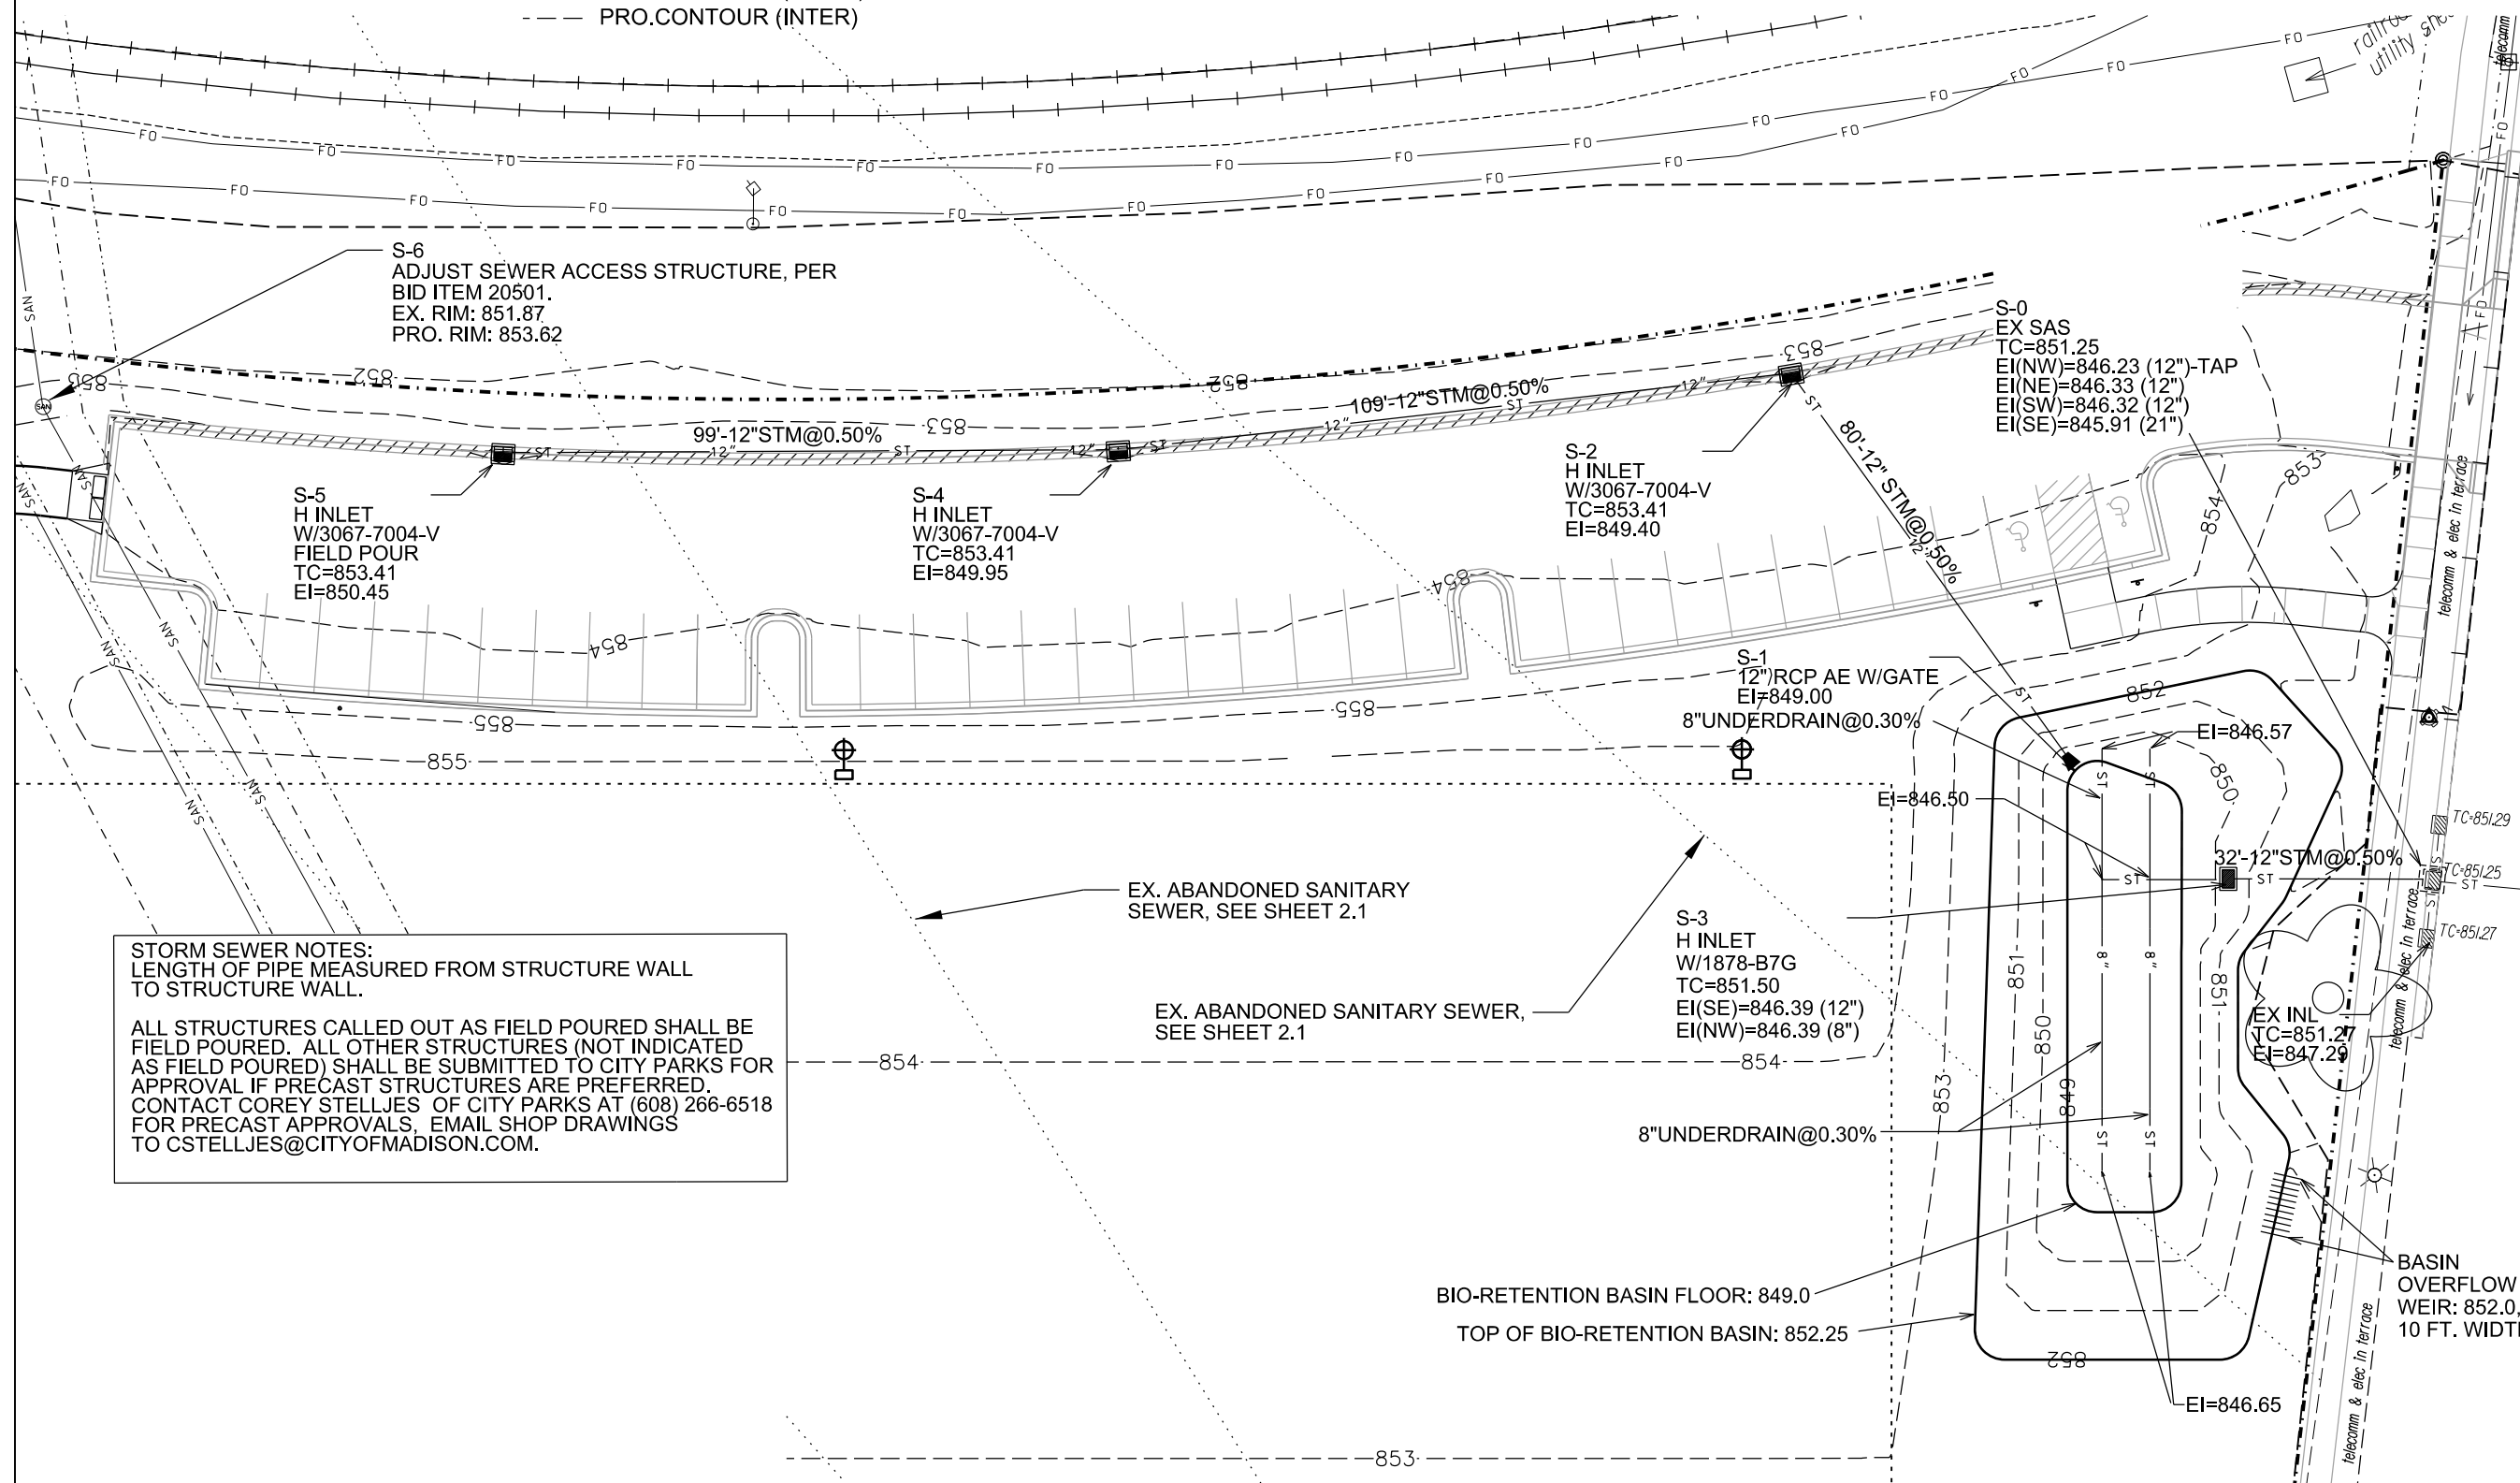

**STORM SEWER NOTES:**  
 LENGTH OF PIPE MEASURED FROM STRUCTURE WALL TO STRUCTURE WALL.  
 ALL STRUCTURES CALLED OUT AS FIELD Poured SHALL BE FIELD Poured. ALL OTHER STRUCTURES (NOT INDICATED AS FIELD Poured) SHALL BE SUBMITTED TO CITY PARKS FOR APPROVAL IF PRECAST STRUCTURES ARE PREFERRED. CONTACT COREY STELLJES OF CITY PARKS AT (608) 266-6518 FOR PRECAST APPROVALS. EMAIL SHOP DRAWINGS TO CSTELLJES@CITYOFMADISON.COM.

EX. ABANDONED SANITARY SEWER, SEE SHEET 2.1

EX. ABANDONED SANITARY SEWER, SEE SHEET 2.1

BIO-RETENTION BASIN FLOOR: 849.0  
 TOP OF BIO-RETENTION BASIN: 852.25

PROJECT:  
**BURR JONES  
 PARK SITE  
 IMPROVEMENTS**

**BURR JONES PARK  
 1820 E. WASHINGTON AVE.  
 MADISON, WI 53704**


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Advertised to bid:	05-30-19


PUBLIC WORKS PROJECT #:  
**8359**

SHEET TITLE:  
**BIO-RETENTION BASIN  
 SECTION**

SHEET NUMBER:  
**7.1**

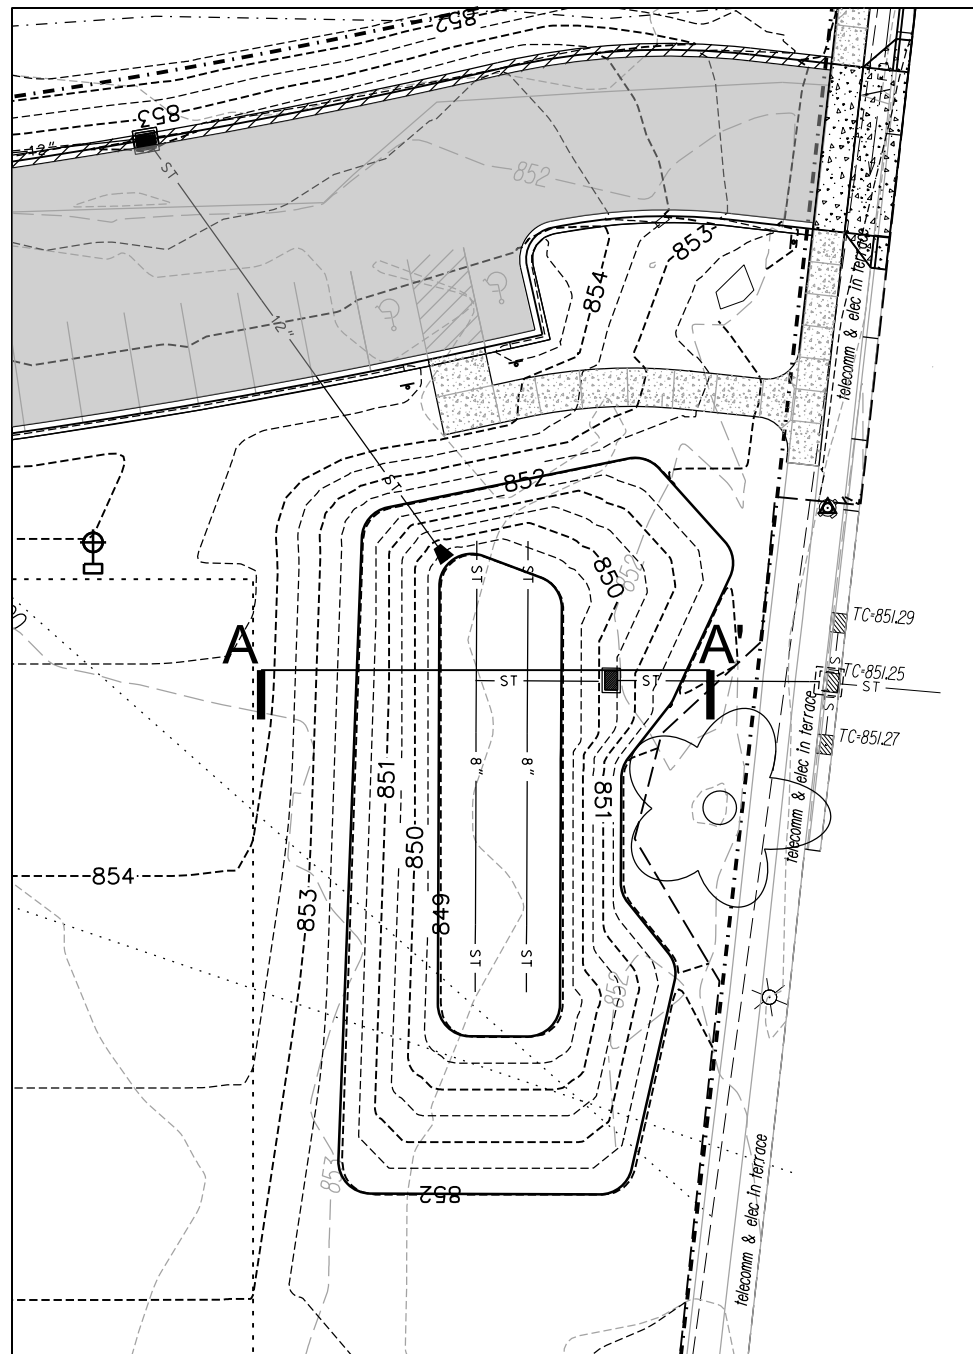


**SITE PLAN - NTS**

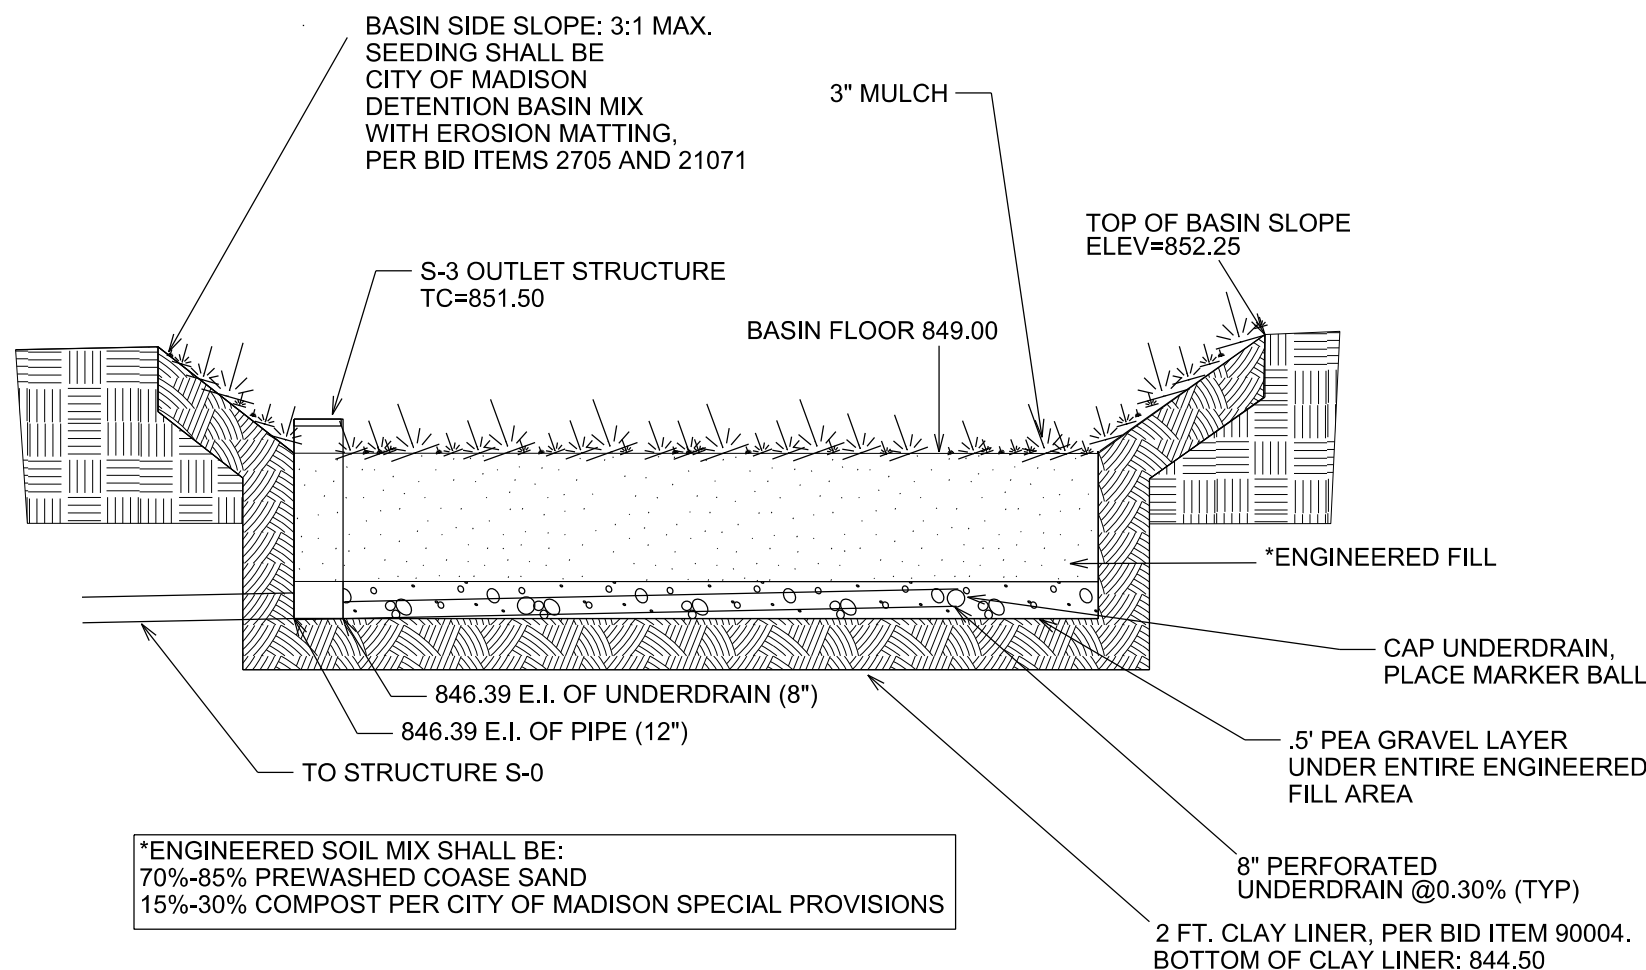

**BIO-RETENTION BASIN CROSS-SECTION A'-A  
 (NOT TO SCALE)**

\*ENGINEERED SOIL MIX SHALL BE:  
 70%-85% PREWASHED COARSE SAND  
 15%-30% COMPOST PER CITY OF MADISON SPECIAL PROVISIONS

BIO RETENTION BASIN PER S.D.D. 2.09  
 TOP OF ENGINEERED FILL = 849.00  
 TOP EXCAVATION= 852.25  
 OVERFLOW WEIR= 852.00  
 BOTTOM EXCAVATION=846.50  
 TOP OF STONE=847.00  
 APPROX GROUNDWATER ELEV=847.90

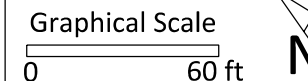

PROJECT:  
**BURR JONES  
 PARK SITE  
 IMPROVEMENTS**

**BURR JONES PARK  
 1820 E. WASHINGTON AVE.  
 MADISON, WI 53704**


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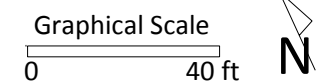
ITEM	DATE
Drawing by: MS	05-23-19
Advertised to bid:	05-30-19

PUBLIC WORKS PROJECT #:  
**8359**

SHEET TITLE:  
**SITE  
 RESTORATION  
 PLAN**

SHEET NUMBER:  
**8.0**



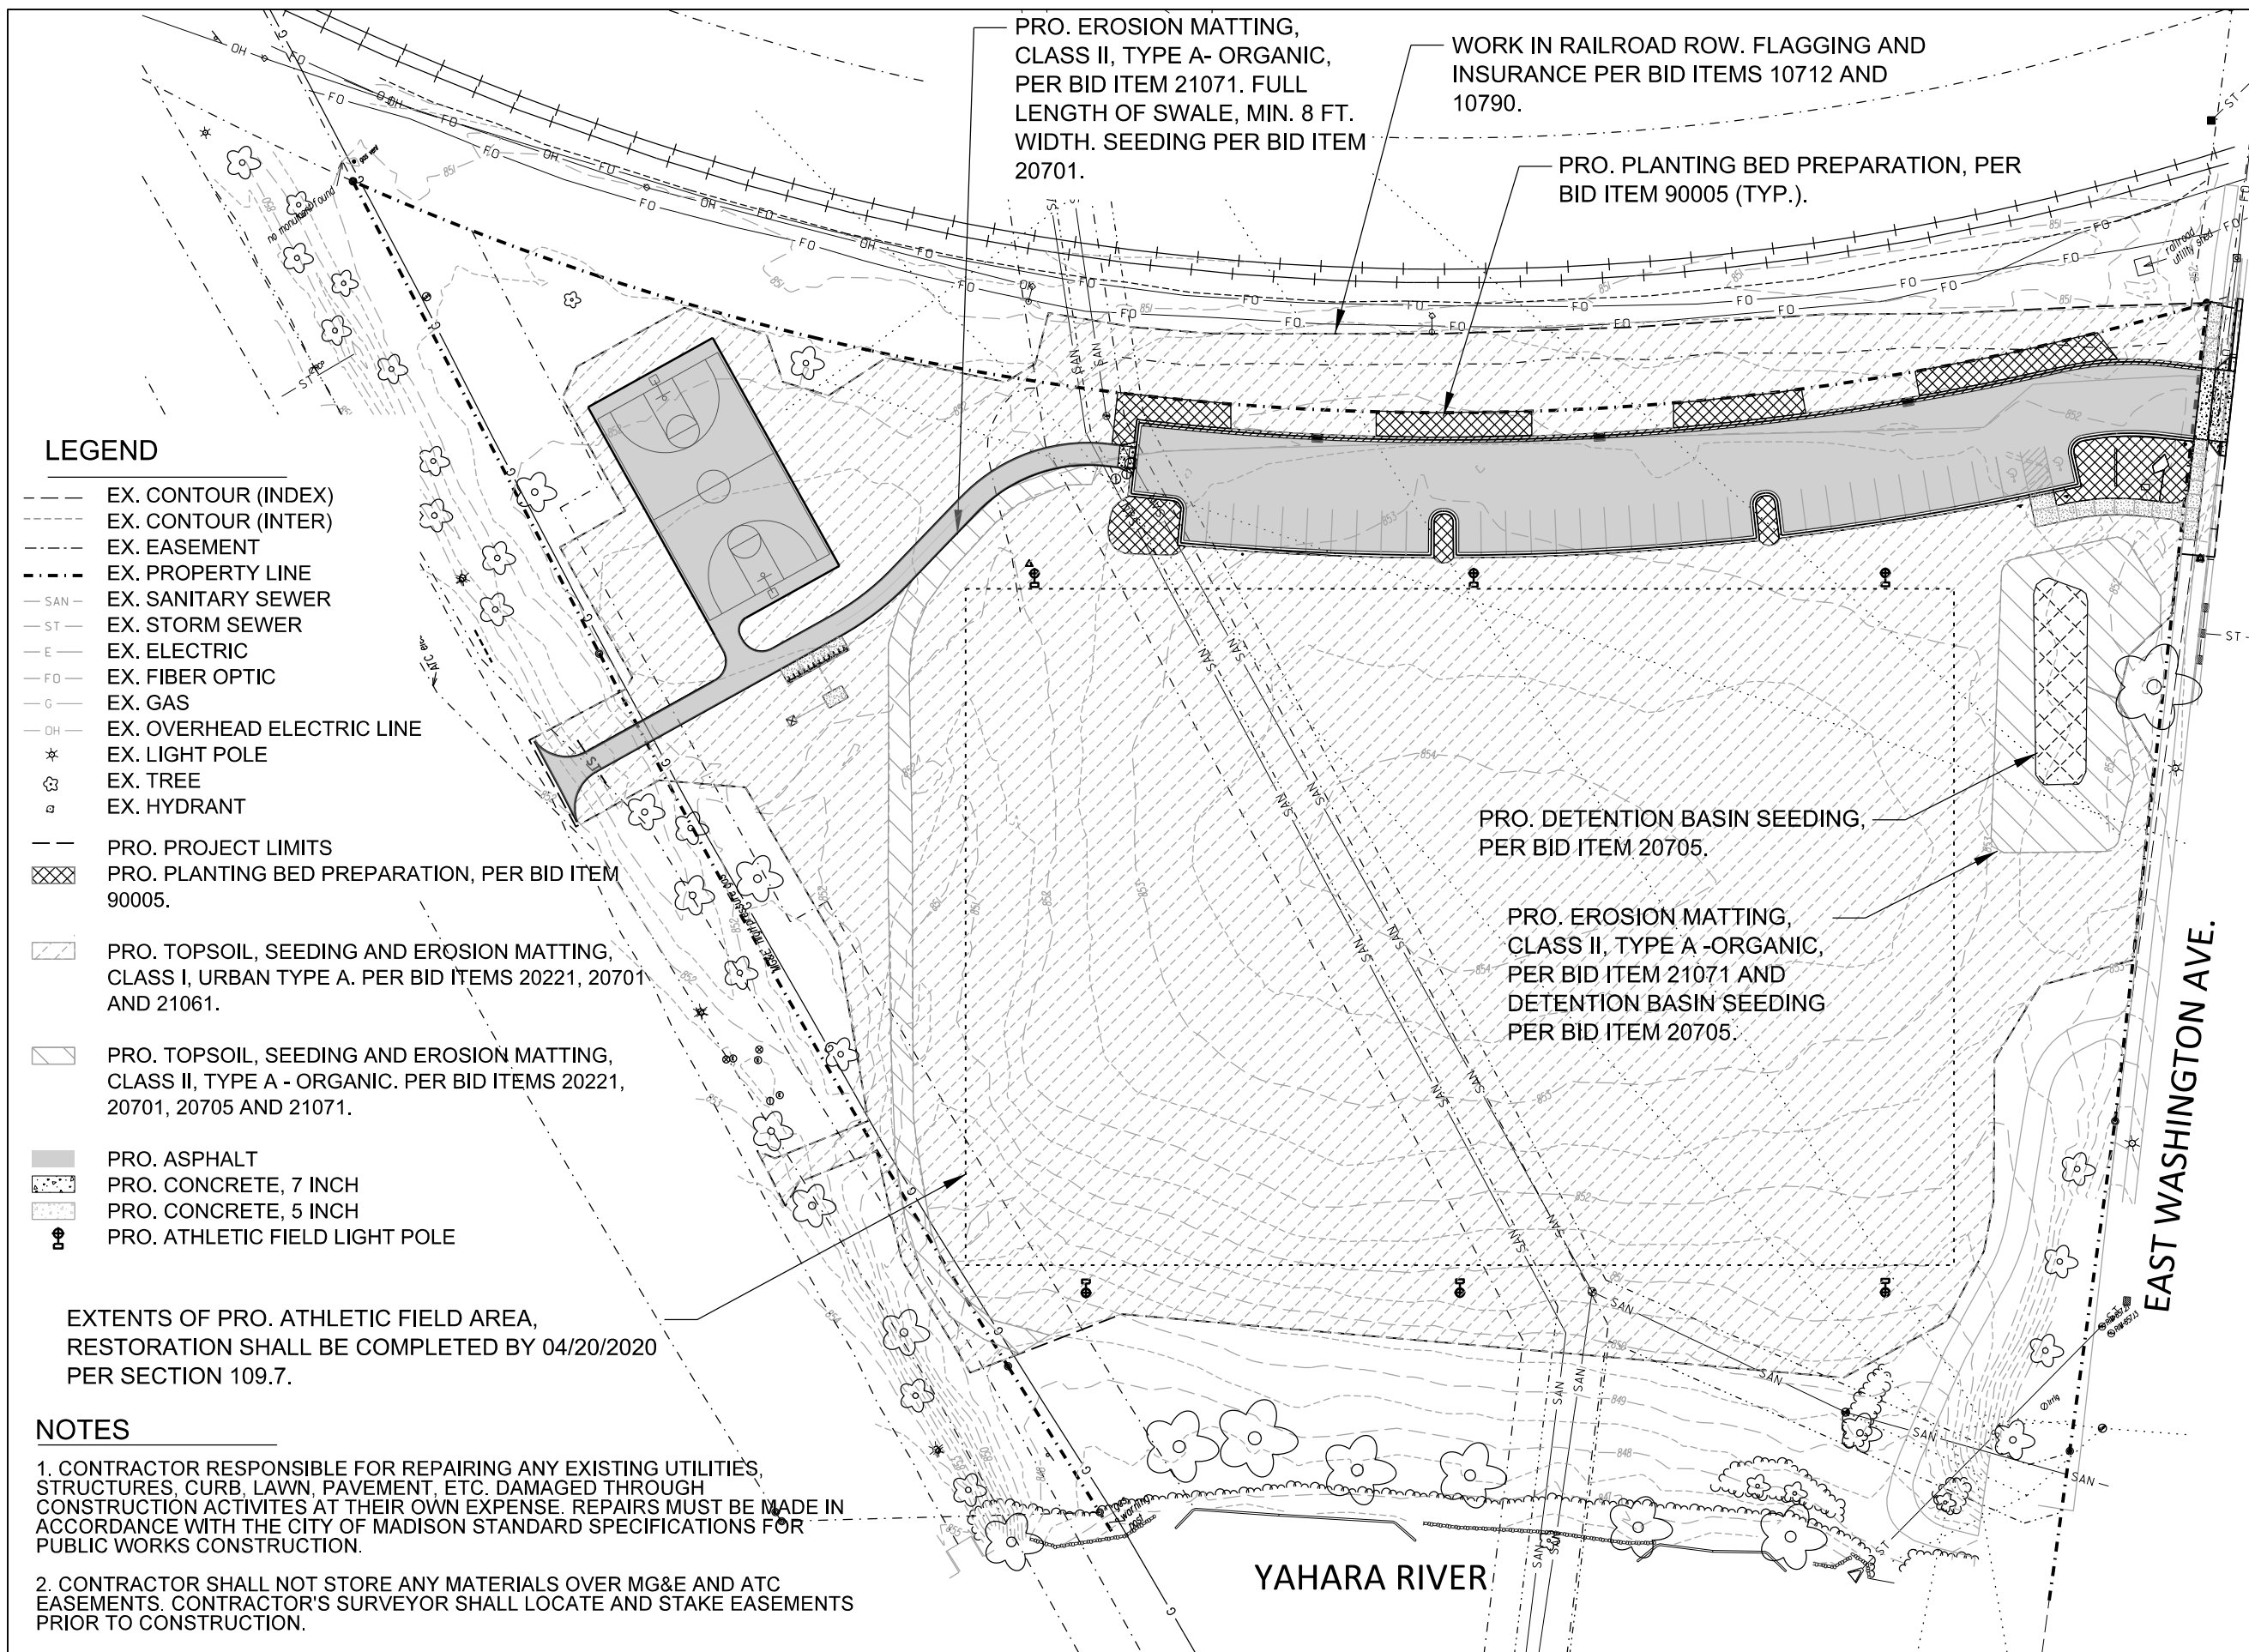

PROJECT:  
**BURR JONES  
 PARK SITE  
 IMPROVEMENTS**

**BURR JONES PARK  
 1820 E. WASHINGTON AVE.  
 MADISON, WI 53704**


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ITEM	DATE
BID SET	05-30-2019

PUBLIC WORKS PROJECT #:  
**8359**

SHEET TITLE:  
**UTILITY PLAN -  
 ELECTRICAL SERVICE**

SHEET NUMBER:  
**9.0**

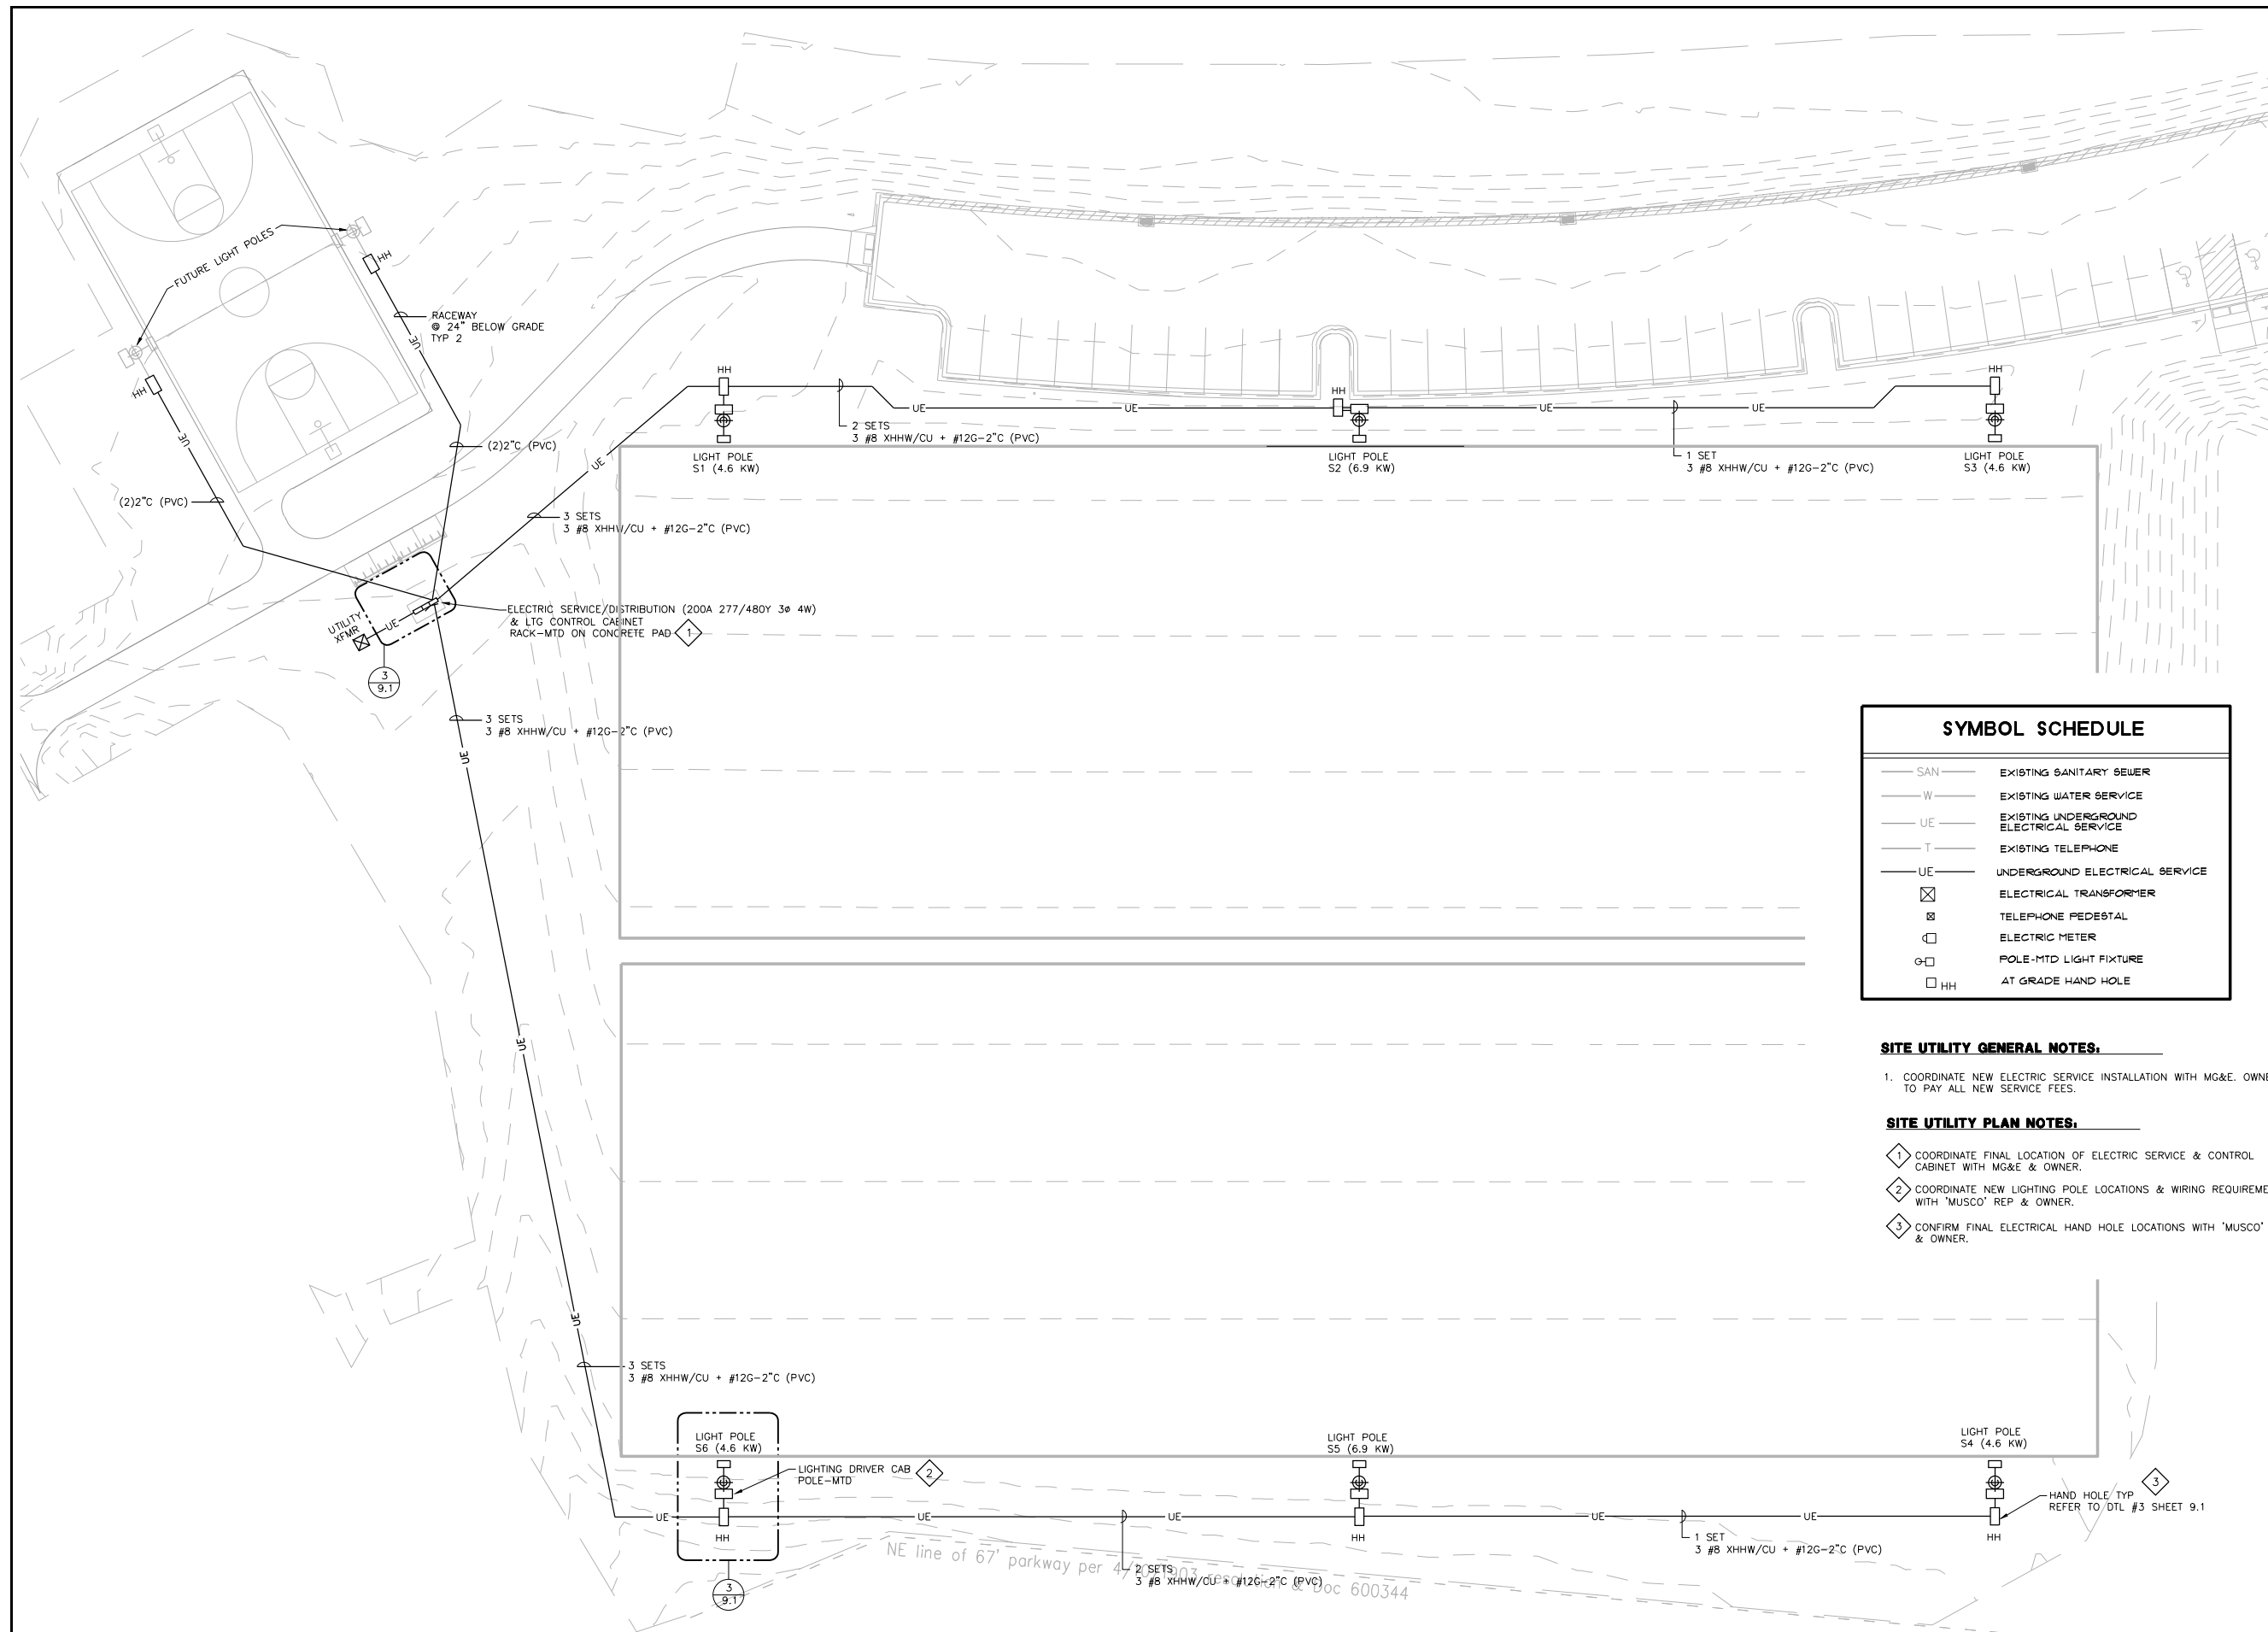

**SYMBOL SCHEDULE**

— SAN —	EXISTING SANITARY SEWER
— W —	EXISTING WATER SERVICE
— UE —	EXISTING UNDERGROUND ELECTRICAL SERVICE
— T —	EXISTING TELEPHONE
— UE —	UNDERGROUND ELECTRICAL SERVICE
⊠	ELECTRICAL TRANSFORMER
⊞	TELEPHONE PEDESTAL
⊞	ELECTRIC METER
⊞	POLE-MTD LIGHT FIXTURE
⊞	AT GRADE HAND HOLE

**SITE UTILITY GENERAL NOTES:**


- COORDINATE NEW ELECTRIC SERVICE INSTALLATION WITH MG&E. OWNER TO PAY ALL NEW SERVICE FEES.

**SITE UTILITY PLAN NOTES:**


- COORDINATE FINAL LOCATION OF ELECTRIC SERVICE & CONTROL CABINET WITH MG&E & OWNER.
- COORDINATE NEW LIGHTING POLE LOCATIONS & WIRING REQUIREMENTS WITH 'MUSCO' REP & OWNER.
- CONFIRM FINAL ELECTRICAL HAND HOLE LOCATIONS WITH 'MUSCO' REF & OWNER.

**1 UTILITY PLAN - ELECTRICAL SERVICE**




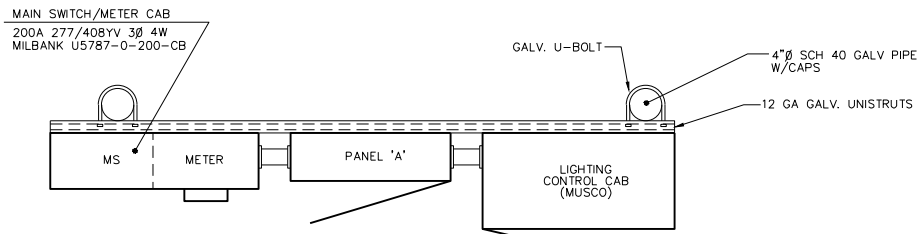


**1 ELECTRIC SERVICE/DISTRIBUTION/CONTROL CAB PLAN**  
N.T.S.

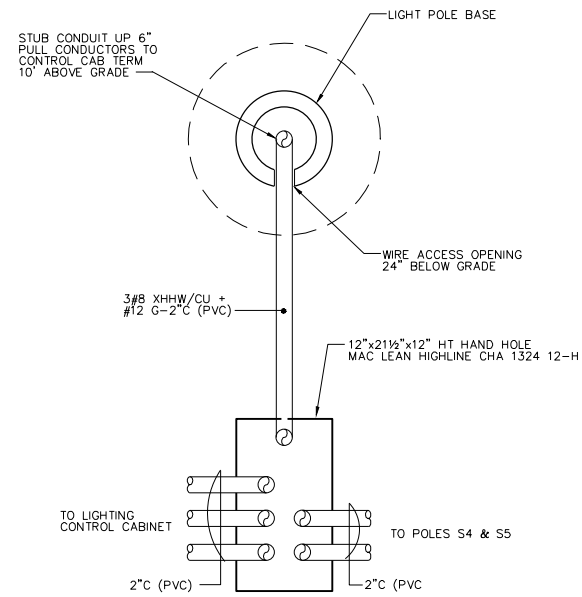


**3 TYPICAL HAND HOLE - LIGHT POLE DETAIL**  
N.T.S.

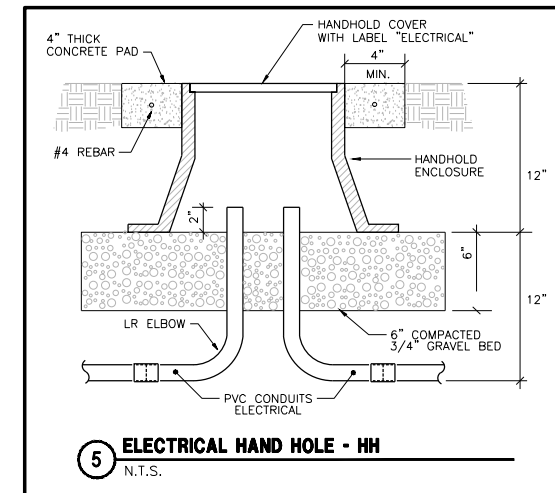


**5 ELECTRICAL HAND HOLE - HH**  
N.T.S.

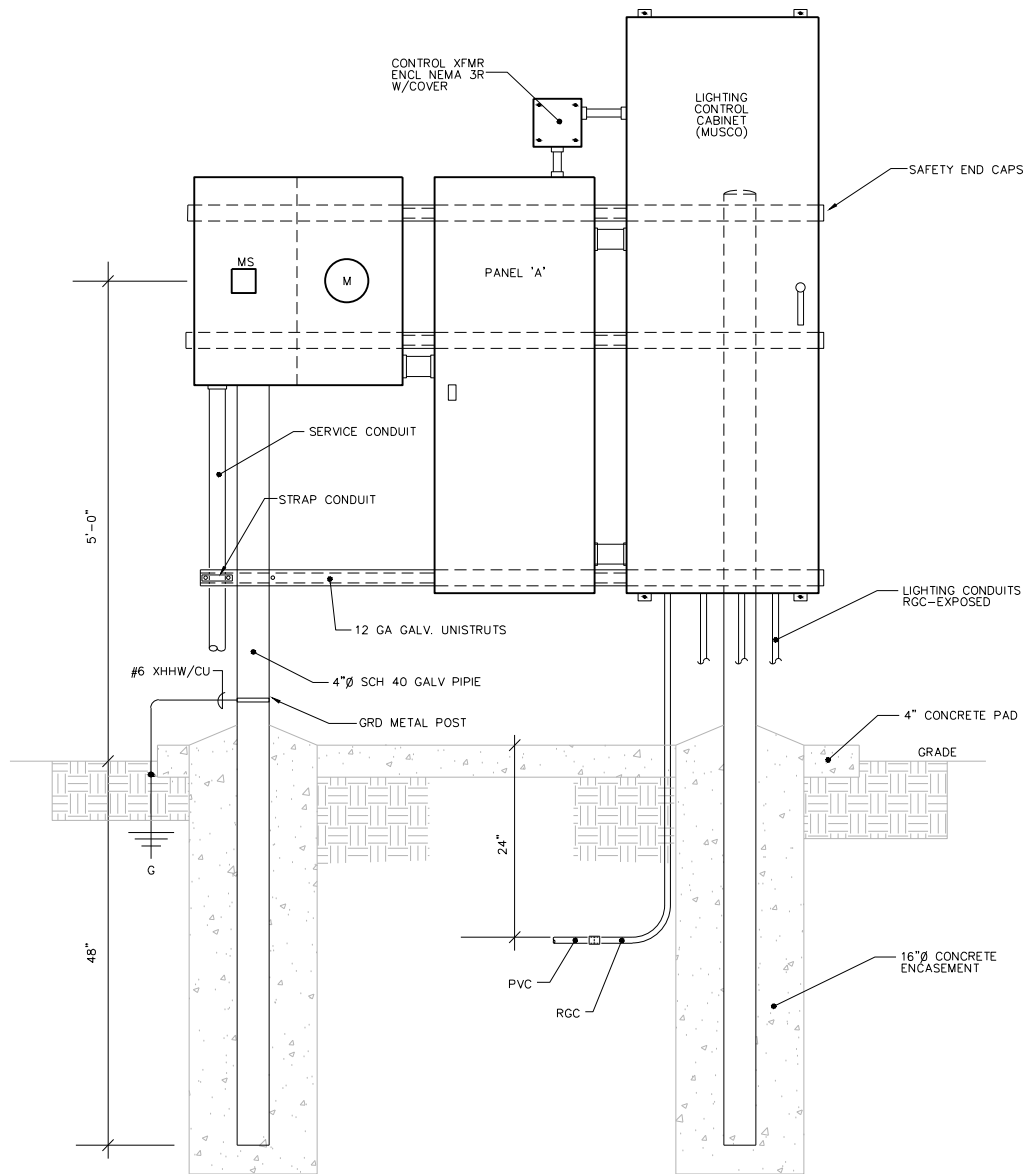

**2 ELECTRIC SERVICE/DISTRIBUTION/CONTROL CAB ELEVATION**  
N.T.S.

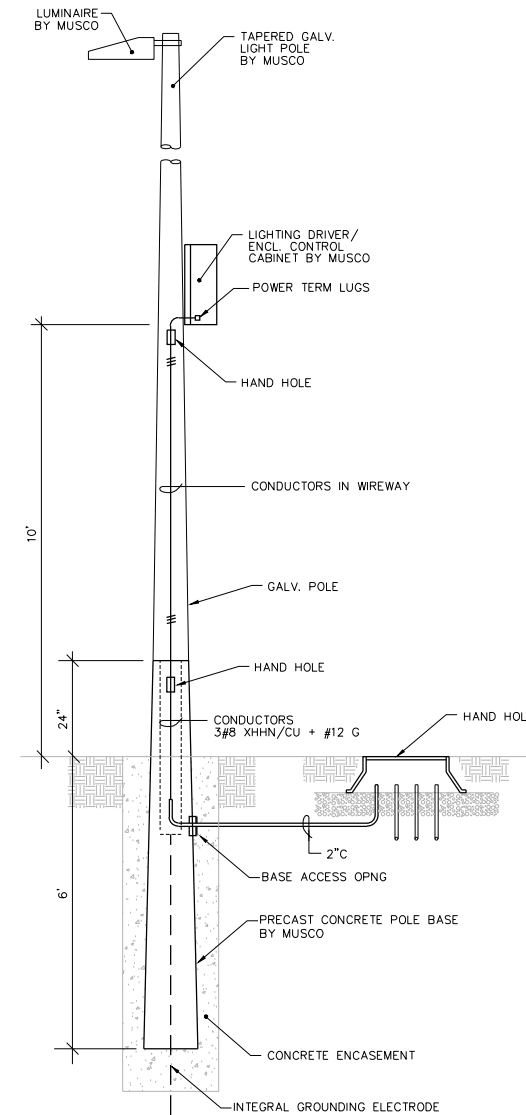

**4 LIGHT POLE WIRING DETAIL**  
N.T.S.

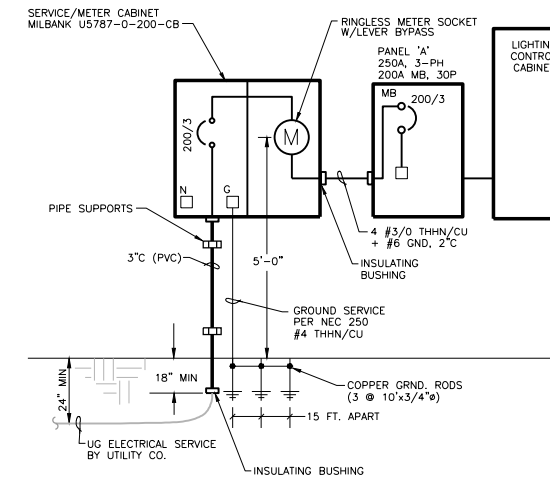

**6 ELECTRICAL SERVICE RISER - MG&E**  
200 AMP 3-PHASE/4-WIRE 277/480V VOLT

PANEL 'A'		AIC=35K NEMA 3R				
AMPS MAIN	MLO	VOLTS	PHASE			
250		277/480	3			
MOUNTING LOCATION		SURFACE EXTERIOR				
BRKR	DESCRIPTION	CIRCUIT WATT	PHASELOADS NO. A B C	CIRCUIT WATT	DESCRIPTION	BRKR
3	LT POLE S1	1540	1 3080	2	1540 LT POLE S4	20 3
-	LT POLE S1	1540	3 3080	4	1540 LT POLE S4	- -
-	LT POLE S1	1540	5 3080	6	1540 LT POLE S4	- -
3	LT POLE S2	2300	7 4600	8	2300 LT POLE S5	20 3
-	LT POLE S2	2300	9 4600	10	2300 LT POLE S5	- -
-	LT POLE S2	2300	11 4600	12	2300 LT POLE S5	- -
3	LT POLE S3	1540	13 3080	14	1540 LT POLE S6	20 3
-	LT POLE S3	1540	15 3080	16	1540 LT POLE S6	- -
-	LT POLE S3	1540	17 3080	18	1540 LT POLE S6	- -
1	CONTROL XFMR	300	19 300	20	- FUTURE POLE	20 3
			21	22	- FUTURE POLE	- -
			23	24	- FUTURE POLE	- -
			25	26	- FUTURE POLE	20 3
			27	28	- FUTURE POLE	- -
			29	30	- FUTURE POLE	- -
		11060 10760 10760				
ESTIMATED DEMAND LOAD:		32,580 WATTS	TOTAL CONNECTED LOADS:		32,580 WATTS	
		39.3 AMPS			39.3 AMPS	

City of Madison  
Department of Public Works  
**PARKS DIVISION**  
City-County Building, Suite 104  
210 Martin Luther King, Jr. Blvd.  
Madison, WI 53703

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**MADISON PARKS**

**HEG**  
HEIN Engineering Group

17 Applegate Court, Suite 200  
Madison, WI 53713  
Phone: (608) 288-9260  
email: hein@heingr.com

PROJECT:  
**BURR JONES PARK SITE IMPROVEMENTS**

**BURR JONES PARK 1820 E. WASHINGTON AVE. MADISON, WI 53704**

Although every effort has been made in preparing these plans and checking them for accuracy, the contractor and subcontractors must check all details and dimensions of their trade and be responsible for the same.

ITEM DATE  
BID SET 05-30-2019

PUBLIC WORKS PROJECT #:  
**8359**

SHEET TITLE:  
**UTILITY PLAN - ELECTRICAL SERVICE DETAILS**

SHEET NUMBER:

**9.1**



### POLE IDENTIFICATION

POLE DESIGNATION	POLE TYPE	PRECAST BASE TYPE	FIXTURE CONFIGURATION (FIX. PER XARM)	FIXTURE AND ACCESSORIES EPA (FT <sup>2</sup> )
S1, S3, S4, S6	LSS70A	3B	4 (4)	12.1
S2, S5	LSS70C	4B	6 (6)	18.6

### DESIGN NOTES

**DESIGN PARAMETERS:**  
 WIND:  $V_{ult} = 115$  MPH,  $V_{asd} = 89$  MPH ( EXPOSURE C, RISK CATEGORY II ) PER INTERNATIONAL BUILDING CODE, 2015 EDITION (ASCE 7-10). DESIGN WIND PARAMETERS ARE AS NOTED, ACTUAL EXPOSURE MUST BE VERIFIED FOR THE SITE BY THE PROPER GOVERNING OFFICIAL.

**GEOTECHNICAL PARAMETERS:**  
 ALLOWABLE END BEARING SOIL PRESSURE: 4,000 PSF  
 ALLOWABLE LATERAL SOIL BEARING PRESSURE:  
 0 PSF/FT (GRADE TO -2'-0"), AS PROVIDED IN SOIL REPORT, TABLE 1 (BELOW -2'-0") IN ACCORDANCE WITH THE 2015 EDITION OF THE INTERNATIONAL BUILDING CODE, CHAPTER 18.

DESIGN SOIL PARAMETERS ARE AS NOTED. ACTUAL ALLOWABLE SOIL PARAMETERS MUST BE VERIFIED ON SITE. REFERENCE GEOTECHNICAL EXPLORATION REPORT, PROJECT NO. C18051-13, PREPARED BY CGC, INC.; MADISON, WI.

A GEOTECHNICAL ENGINEER OR REPRESENTATIVE OF IS RECOMMENDED (NOT REQUIRED) TO BE AVAILABLE AT THE TIME OF THE FOUNDATION INSTALLATION TO VERIFY THE SOIL DESIGN PARAMETERS AND TO PROVIDE ASSISTANCE IF ANY PROBLEMS ARISE IN FOUNDATION INSTALLATION.

ENCOUNTERING SOIL FORMATIONS THAT WILL REQUIRE SPECIAL DESIGN CONSIDERATIONS OR EXCAVATION PROCEDURES MAY OCCUR. POLE FOUNDATIONS WILL NEED TO BE ANALYZED ACCORDING TO THE SOIL CONDITIONS THAT EXIST. IF ANY DISCREPANCIES OR INCONSISTENCIES ARISE, NOTIFY THE ENGINEER OF SUCH DISCREPANCIES. FOUNDATIONS WILL THEN BE REVISED ACCORDINGLY. REVISIONS WILL BE ANALYZED PER RECOMMENDATIONS DIRECTED BY A LICENSED ENGINEER.

ALL EXCAVATIONS MUST BE FREE OF LOOSE SOIL AND DEBRIS PRIOR TO FOUNDATION INSTALLATION AND CONCRETE BACKFILL PLACEMENT. TEMPORARY CASINGS OR DRILLERS SLURRY MAY BE USED TO STABILIZE THE EXCAVATION DURING INSTALLATION. CASINGS MUST BE REMOVED DURING CONCRETE BACKFILL PLACEMENT. CONCRETE BACKFILL MUST BE PLACED WITH A TREMIE WHEN SLURRY OR WATER IS PRESENT WITHIN THE EXCAVATION OR WHEN THE FREE DROP EXCEEDS 6'-0".

CONTRACTOR MUST BE FAMILIAR WITH THE COMPLETE SOIL INVESTIGATION REPORT AND BORINGS, AND CONTACT THE GEOTECHNICAL FIRM (IF NECESSARY) TO UNDERSTAND THE SOIL CONDITIONS AND THE POSSIBILITY OF GROUND WATER PUMPING AND EXCAVATION STABILIZATION OR BRACING DURING PRECAST BASE INSTALLATION AND PLACEMENT OF CONCRETE BACKFILL.

**GENERAL NOTES:**  
 FIXTURES MUST BE LOCATED TO MAINTAIN 10'-0" MINIMUM HORIZONTAL CLEARANCE FROM ANY OBSTRUCTION. ENGINEER MUST BE NOTIFIED IF FOUNDATIONS ARE NEAR ANY RETAINING WALLS OR WITHIN / NEAR ANY SLOPES STEEPER THAN 3H : 1V. POLES, FIXTURES, PRECAST BASES, ELECTRICAL ITEMS AND INSTALLATION PER MUSCO LIGHTING.

### CONCRETE/REINFORCEMENT NOTES

CONCRETE SHALL COMPLY WITH THE FOLLOWING ASTM STANDARDS: MIXTURE WITH ASTM C-94, PORTLAND CEMENT WITH ASTM C-150 TYPE 1-A, AGGREGATES (0.75" MAX) WITH ASTM C-33 AND BE IN CONFORMANCE WITH ACI 318.

CONCRETE SHALL BE AIR-ENTRAINED (COMPLY WITH ASTM C-260), HAVE A MAXIMUM WATER -CEMENT RATIO, w/cm = 0.45 AND HAVE A MINIMUM COMPRESSIVE STRENGTH AT 28 DAYS OF 4,000 PSI.


DESIGN SLUMP LIMITS ARE 4" MINIMUM AND 6" MAXIMUM. THE JOB SITE SLUMP MAY BE INCREASED BY THE USE OF A WATER REDUCING AGENT MEETING ASTM C494-92.

CONCRETE REINFORCEMENT SHALL COMPLY WITH ASTM A615 GRADE 60 AND BE IN CONFORMANCE WITH ACI 315 & 318.

CONCRETE DRILLED PIERS MUST ATTAIN 3,000 PSI STRENGTH PRIOR TO POLE INSTALLATION AND FIXTURE MOUNTING.

THE DEPTH EQUAL TO THE PRECAST BASE EMBEDMENT SHALL BE THOROUGHLY CONSOLIDATED BY MECHANICAL VIBRATION DURING PLACEMENT.

**INSTALLATION NOTE:**  
 CONCRETE TO BE PLACED IN A CONTINUOUS POUR OR A COLD JOINT WILL BE ACCEPTABLE AT THE BOTTOM OF THE PRECAST BASE. TWO POUR: WITH THE REINFORCEMENT IN PLACE, THE CONCRETE BELOW THE BOTTOM OF THE PRECAST BASE MAY BE Poured AND ALLOWED TO SET UP LONG ENOUGH TO SUPPORT WEIGHT OF PRECAST BASE. THEN THE PRECAST BASE MAY BE SET IN PLACE AND THE REST OF THE CONCRETE CONCRETE BACKFILL Poured. DEPENDING ON THE DEPTH TO GROUND WATER AT THE TIME OF INSTALLATION, THE TWO POUR METHOD UTILIZING A COLD JOINT MAY NOT BE FEASIBLE.

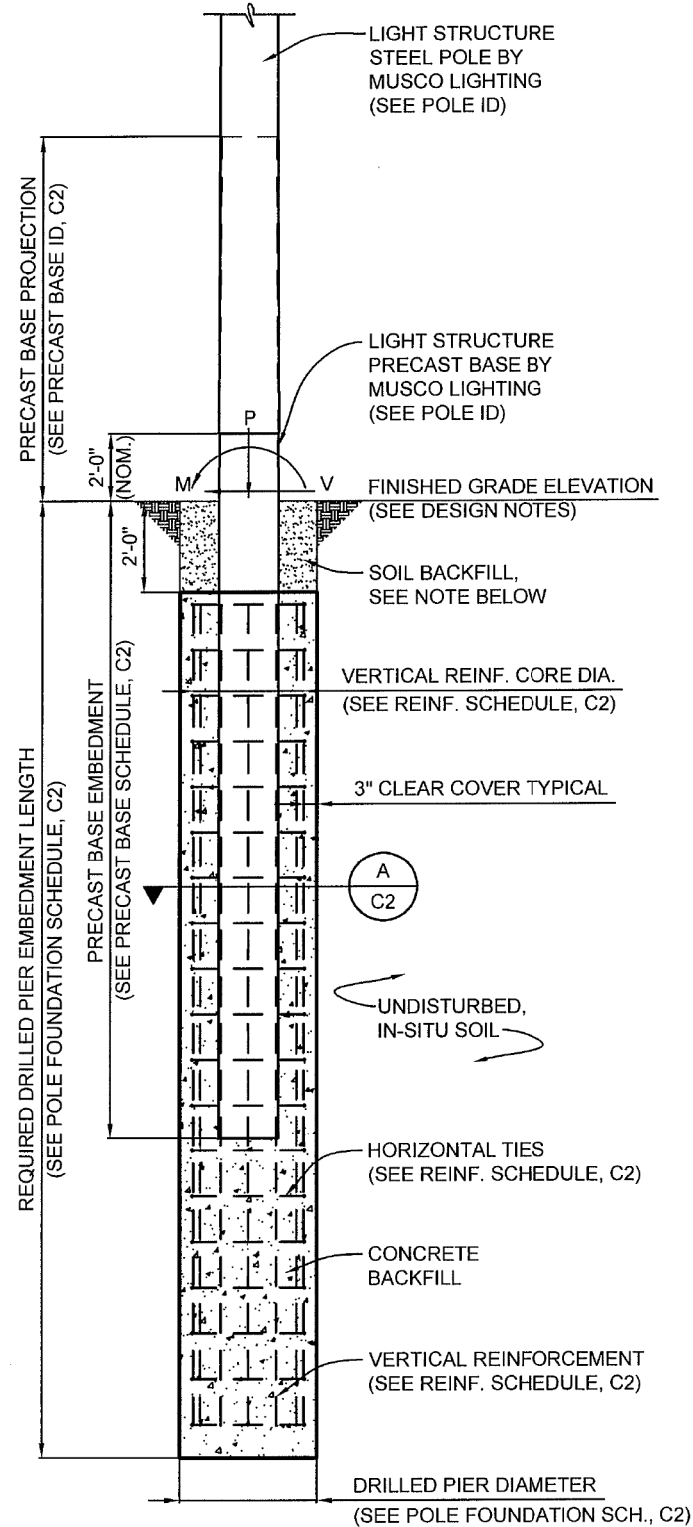

### POLE FOUNDATION ELEVATION

SCALE: NOT TO SCALE

**SOIL BACKFILL NOTE:**  
 THE TOP TWO FEET OF ANNULUS SHALL BE BACKFILLED WITH SOIL, WITH A CLASSIFICATION OF CLASS 5 (TABLE 1806.2) OR BETTER. COMPACTION, 95% FOR COHESIVE SOIL AND 98% FOR A COHESIONLESS SOIL BASED UPON STANDARD PROCTOR TESTING (ASTM D698).



KYLE G. LACINA - NO. 42333

City of Madison  
 Department of Public Works  
 PARKS DIVISION

City-County Building, Suite 104  
 210 Martin Luther King, Jr. Blvd.  
 Madison, WI 53703

play  
**MADISON  
 PARKS**

PROJECT:

**BURR JONES  
 PARK SITE  
 IMPROVEMENTS**

**BURR JONES PARK  
 1820 E. WASHINGTON AVE.  
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ITEM	DATE
Drawing by: MS	05-23-19
Advertised to bid:	05-30-19

PUBLIC WORKS PROJECT #:  
**8359**

SHEET TITLE:  
**ATHLETIC FIELD  
 LIGHTING - POLE  
 FOOTINGS**

SHEET NUMBER:  
**10.0**

# Burr Jones Park

Madison, WI

## Lighting System

Pole / Fixture Summary						
Pole ID	Pole Height	Mtg Height	Fixture Qty	Luminaire Type	Load	Circuit
S1, S3-S4, S6	70'	70'	4	TLC-LED-1150	4.60 kW	A
S2, S5	70'	70'	6	TLC-LED-1150	6.90 kW	A
<b>6</b>			<b>28</b>		<b>32.20 kW</b>	

Circuit Summary			
Circuit	Description	Load	Fixture Qty
A	Soccer	32.2 kW	28

Fixture Type Summary							
Type	Source	Wattage	Lumens	L90	L80	L70	Quantity
TLC-LED-1150	LED 5700K - 75 CRI	1150W	121,000	>81,000	>81,000	>81,000	28

## Light Level Summary

Calculation Grid Summary								
Grid Name	Calculation Metric	Illumination					Circuits	Fixture Qty
		Ave	Min	Max	Max/Min	Ave/Min		
Blanket Grid	Horizontal	8.80	0	46	119023500.00		A	28
Property Line	Horizontal	0.15	0	0.44	9447.37		A	28
Soccer	Horizontal Illuminance	33.5	24	42	1.77	1.40	A	28
Ultimate Field 1	Horizontal Illuminance	33.5	25	42	1.70	1.34	A	28
Ultimate Field 2	Horizontal Illuminance	33.4	22	41	1.85	1.52	A	28

## From Hometown to Professional



City of Madison  
Department of Public Works  
**PARKS DIVISION**

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Madison, WI 53703

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**MADISON  
PARKS**

PROJECT:

*BURR JONES  
PARK SITE  
IMPROVEMENTS*

*BURR JONES PARK  
1820 E. WASHINGTON AVE.  
MADISON, WI 53704*

Although every effort has been made in preparing these plans and checking them for accuracy, the contractor and subcontractors must check all details and dimensions of their trade and be responsible for the same.

ITEM	DATE
Drawing by: MS	05-23-19
Advertised to bid:	05-30-19

PUBLIC WORKS PROJECT #:  
**8359**

SHEET TITLE:  
**ATHLETIC FIELD  
LIGHTING - POLE  
SCHEDULE**

SHEET NUMBER:  
**10.1**



**We Make It Happen.**


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ENGINEERED DESIGN By: Connor Ramstead • File #191142CR1 • 07-Jan-19

**PROJECT SUMMARY**

**EQUIPMENT LIST FOR AREAS SHOWN**

Pole				Luminaires				
QTY	LOCATION	SIZE	GRADE ELEVATION	MOUNTING HEIGHT	LUMINAIRE TYPE	QTY/ POLE	THIS GRID	OTHER GRIDS
4	S1, S3-S4 S6	70'	-	70'	TLC-LED-1150	4	4	0
2	S2, S5	70'	-	70'	TLC-LED-1150	6	6	0
6	TOTALS					28	28	0

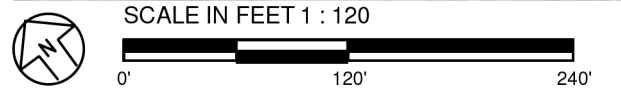

ENGINEERED DESIGN By: Connor Ramstead • File #191142CR1 • 07-Jan-19

Pole location(s) ⊕ dimensions are relative to 0,0 reference point(s) ⊗

**Burr Jones Park**

Madison, WI

GRID SUMMARY	
Name:	Blanket Grid
Spacing:	30.0' x 30.0'
Height:	3.0' above grade

ILLUMINATION SUMMARY			
MAINTAINED HORIZONTAL FOOTCANDLES			
		Entire Grid	
Scan Average:	8.80		
Maximum:	46		
Minimum:	0		
No. of Points:	425		
LUMINAIRE INFORMATION			
Color / CRI:	5700K - 75 CRI		
Luminaire Output:	121,000 lumens		
No. of Luminaires:	28		
Total Load:	32.2 kW		
Lumen Maintenance			
Luminaire Type	L90 hrs	L80 hrs	L70 hrs
TLC-LED-1150	>81,000	>81,000	>81,000
Reported per TM-21-11. See luminaire datasheet for details.			

**Guaranteed Performance:** The ILLUMINATION described above is guaranteed per your Musco Warranty document and includes a 0.95 dirt depreciation factor.

**Field Measurements:** Individual field measurements may vary from computer-calculated predictions and should be taken in accordance with IESNA RP-6-15.

**Electrical System Requirements:** Refer to Amperage Draw Chart and/or the "Musco Control System Summary" for electrical sizing.

**Installation Requirements:** Results assume ± 3% nominal voltage at line side of the driver and structures located within 3 feet (1m) of design locations.



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**ILLUMINATION SUMMARY**

City of Madison  
Department of Public Works  
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PROJECT:  
**BURR JONES  
PARK SITE  
IMPROVEMENTS**

**BURR JONES PARK  
1820 E. WASHINGTON AVE.  
MADISON, WI 53704**

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Drawing by: MS	05-23-19
Advertised to bid:	05-30-19

PUBLIC WORKS PROJECT #:  
**8359**

SHEET TITLE:  
**ATHLETIC FIELD  
LIGHTING -  
PHOTOMETRICS**

SHEET NUMBER:  
**10.2**

City of Madison  
Department of Public Works  
**PARKS DIVISION**

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PROJECT:

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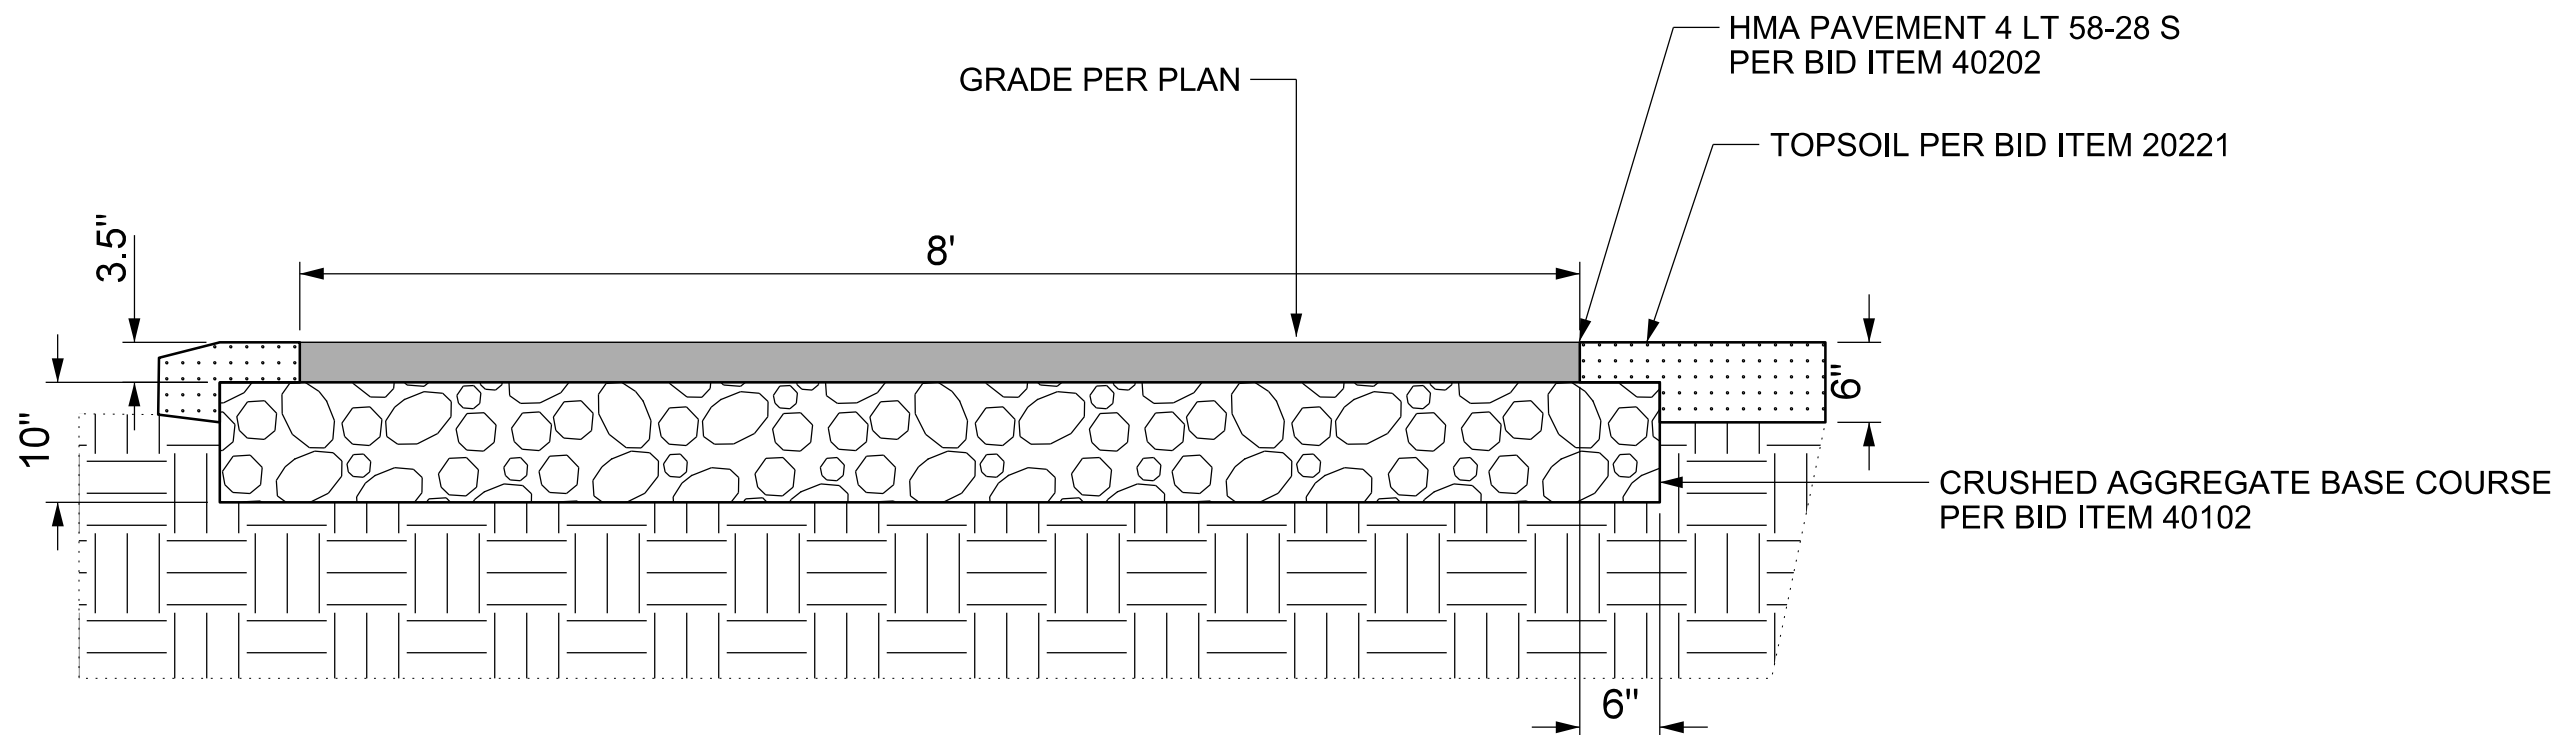
ITEM	DATE
Drawing by: MS	05-23-19
Advertised to bid:	05-30-19

PUBLIC WORKS PROJECT #:  
**8359**

SHEET TITLE:  
**SITE DETAILS - PATH  
SECTION**





SHEET NUMBER:

**11.0**





4/22/2011

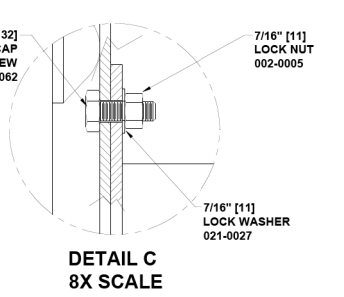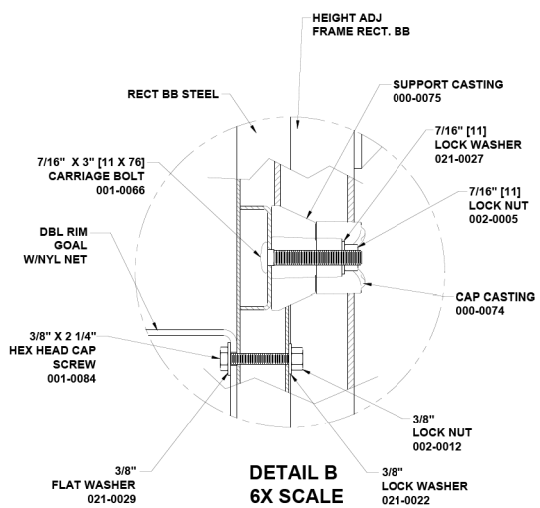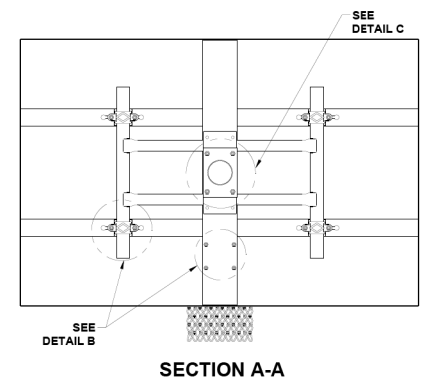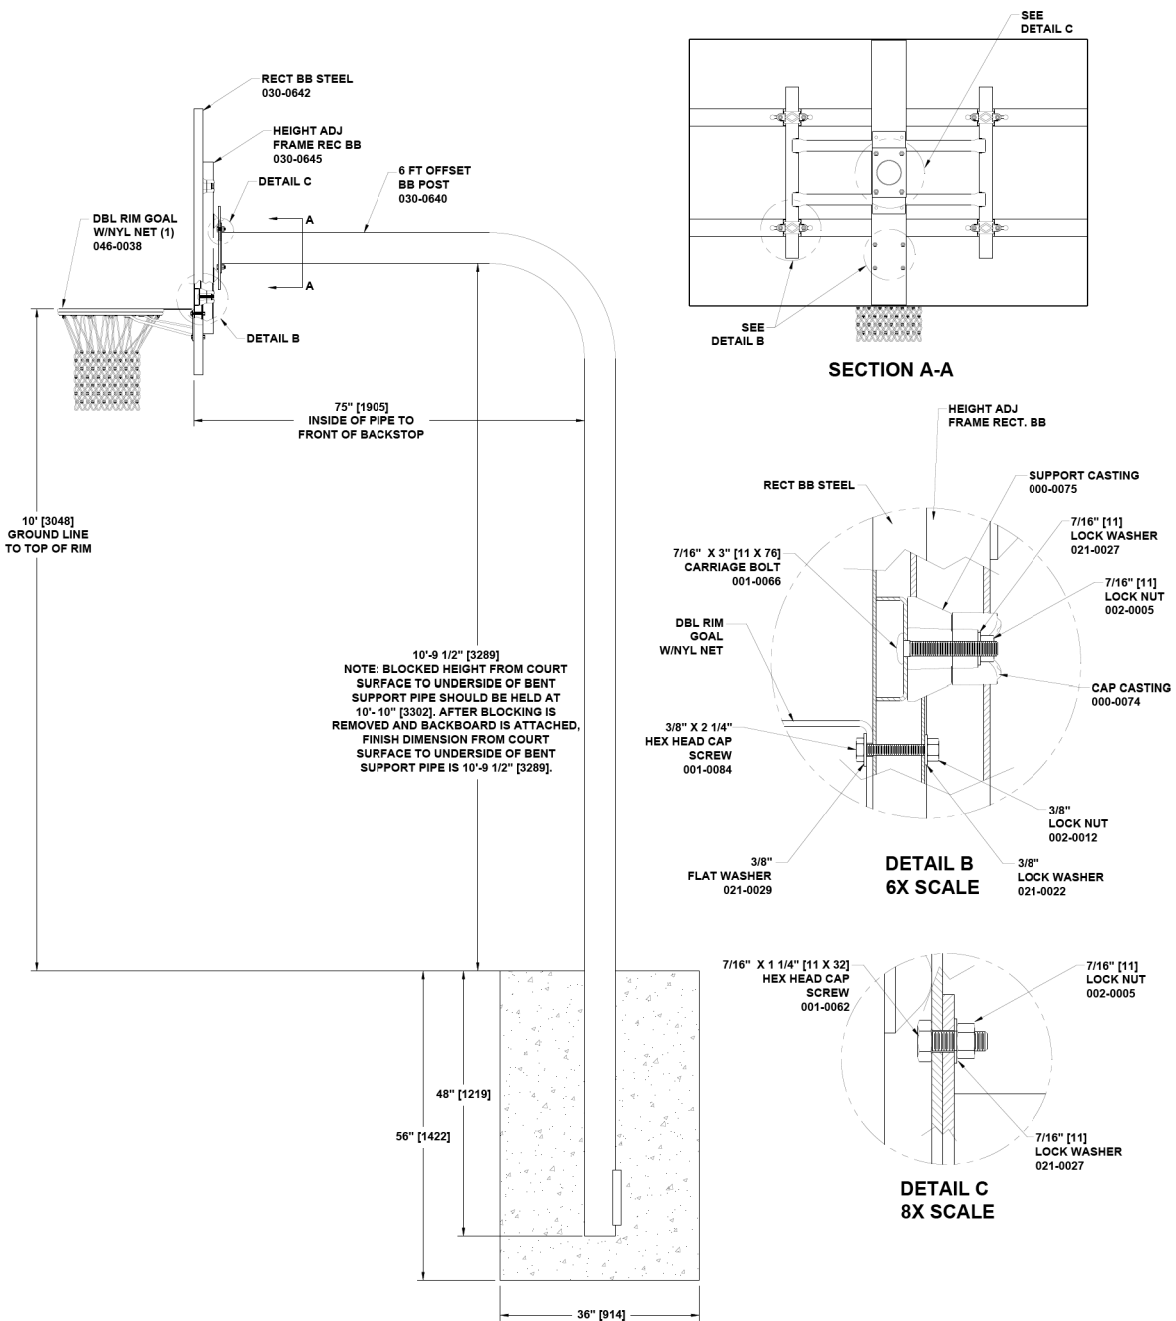

**590-0039**  
**RECT BB DBL RIM NYL 6' (1)**

PART NO.	DESCRIPTION	QTY
000-0074	CAP CASTING	4
000-0075	SUPPORT CASTING	4
030-0640	6 FT OFFSET BACKBOARD POST	1
030-0642	RECT BACKBOARD STEEL	1
030-0645	HEIGHT ADJ FRAME RECTANGLE BACKBOARD	1
036-0164	HARDWARE PACKAGE	1
046-0038	DOUBLE RIM GOAL W/NYLON NET (1)	1

Note: Hardware package(s) may include extra hardware that is not necessary for this installation.

**SPECIFICATIONS**

**CAP CASTING; SUPPORT CASTING:** Hot-dipped galvanized, grade 32510, malleable iron.

**6 FT OFFSET BACKBOARD POST:** One piece all welded construction consisting of 5 9/16" OD x sch. 40 galvanized steel pipe, 1/4" HR steel plate, and 1 1/2" x 1 1/2" x 1/4" HR steel angle.

**RECT BACKBOARD STEEL:** One piece all welded construction consisting of 4' x 6' x 12 GA steel sheet with a 1/2" reinforced perimeter and 12 GA channel braces. Primed and finished with baked on powder coat on front side. Coated with sound-deadening rust inhibitor on back side.

**HEIGHT ADJ FRAME RECTANGLE BACKBOARD:** One piece all welded construction consisting of 2 3/8" OD x 10 GA & 1.900" OD x 11 GA galvanized steel tubing, 3/8" dia. HR steel round, and 1/4" HR steel plate. Finished in a baked on powder coat.

**HARDWARE PACKAGE:** Zinc plated steel carriage bolts, hex head capscrews, lock nuts and lock washers.

**DOUBLE RIM GOAL W/NYLON NET (1):** 18" diameter regulation size rim, 5/8" round steel, no-tie clips and nylon net. Rim is finished with an orange baked on powder coat.

**SHIPPING WEIGHT: 526 LBS.**

**INSTALLATION INSTRUCTIONS**

1. Dig footings as shown. NOTE: Hole size may vary depending on local soil and weather conditions.
2. Place bent support pipe into footing to ground line marked on pipe. Block and plumb square to court. **NOTE:** Blocked height from court surface to underside of bent support pipe should be held at 10'-10 1/2". See drawing. Adjust if necessary.
3. Pour concrete and let set for 2 to 3 days.

**AFTER CONCRETE HAS SET:**

4. Remove blocking and fasten attachment frame to backboard. Insert 7/16" x 3" C.B. through backboard and castings. Position attachment frame on support castings and attach cap castings. Fasten using 7/16" lock washers and 7/16" nuts. When all castings are in position, tap castings into alignment and tighten all hardware. See DETAIL B.
5. Raise backboard to position. Fasten bent support pipe to center hole position on attachment frame using 7/16" x 1 1/4" H.H.B., 7/16" lock washers and 7/16" lock nuts. See SECTION A-A and DETAIL C.
6. Fasten goal to backboard using 3/8" x 2 1/4" hex head cap screws, 3/8" lock nuts 3/8" flat washers and 3/8" lock washers. See SECTION A-A and DETAIL B. Hang net.
7. Tighten all hardware.

**NOTE:** BLOCKED HEIGHT FROM COURT SURFACE TO UNDERSIDE OF BENT SUPPORT PIPE SHOULD BE HELD AT 10'-10". SEE DRAWING. AFTER BLOCKING IS REMOVED AND BACKBOARD IS ATTACHED, FINISH DIMENSION FROM COURT SURFACE TO UNDERSIDE OF BENT SUPPORT PIPE IS 10'-9 1/2".

590-0039.doc Description: RECT BB DBL RIM NYL 6'(1)  
REV: 04 PCN: 11-0092 4/22/2011

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**MADISON PARKS**

PROJECT:  
**BURR JONES PARK SITE IMPROVEMENTS**

**BURR JONES PARK**  
1820 E. WASHINGTON AVE.  
MADISON, WI 53704


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Advertised to bid:	05-30-19

PUBLIC WORKS PROJECT #:  
**8359**

SHEET TITLE:  
**SITE DETAILS**  
**BASKETBALL GOAL**

SHEET NUMBER:  
**11.1**

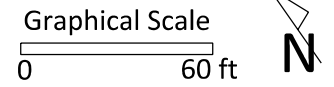

PROJECT:  
**BURR JONES  
 PARK SITE  
 IMPROVEMENTS**

**BURR JONES PARK  
 1820 E. WASHINGTON AVE.  
 MADISON, WI 53704**


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PUBLIC WORKS PROJECT #:  
**8359**

SHEET TITLE:  
**SITE DETAILS - FENCE**

SHEET NUMBER:  
**11.2**



**LEGEND**

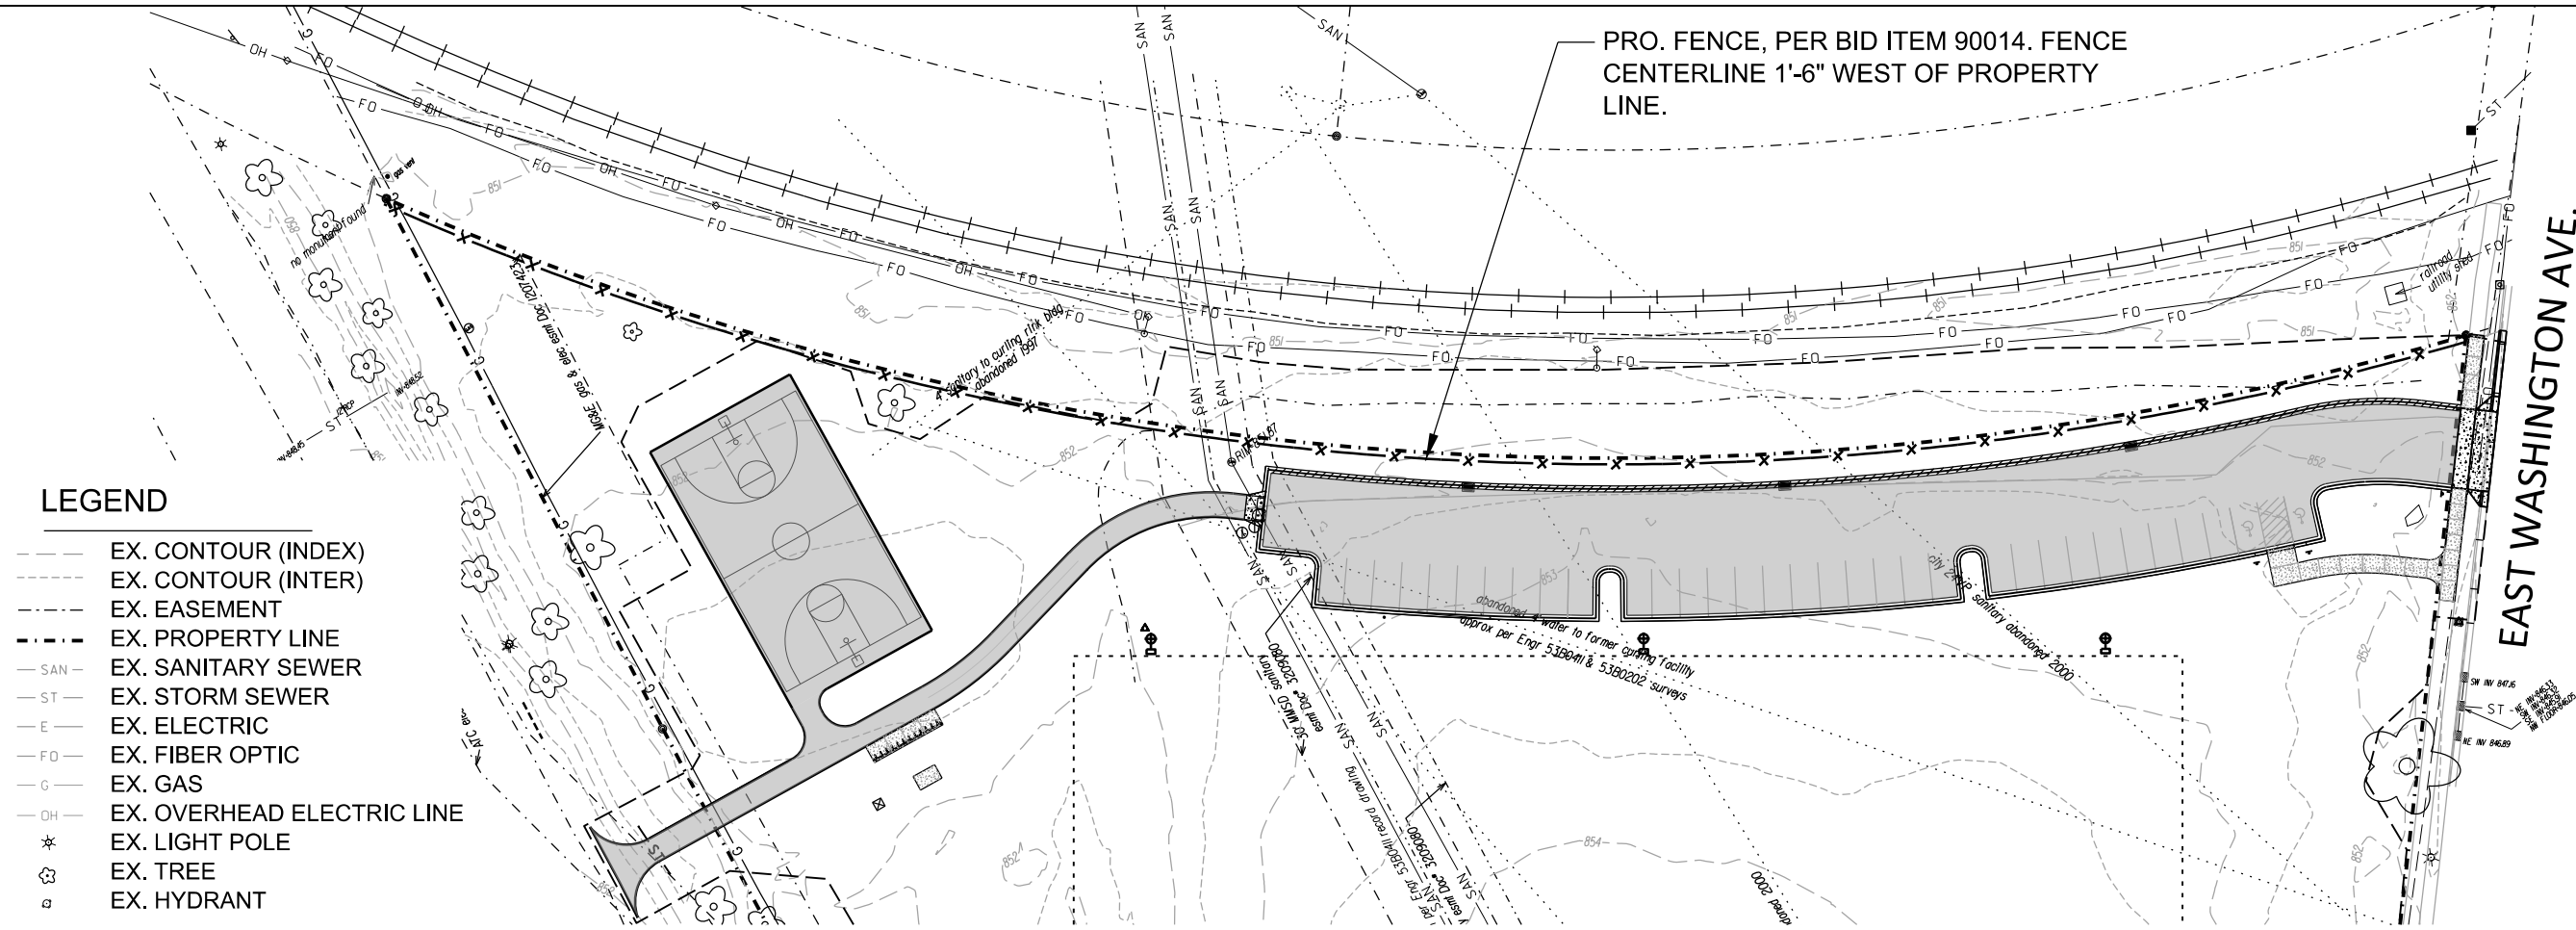- EX. CONTOUR (INDEX)
- - - EX. CONTOUR (INTER)
- - - EX. EASEMENT
- - - EX. PROPERTY LINE
- SAN - EX. SANITARY SEWER
- ST - EX. STORM SEWER
- E - EX. ELECTRIC
- FO - EX. FIBER OPTIC
- G - EX. GAS
- OH - EX. OVERHEAD ELECTRIC LINE
- \* EX. LIGHT POLE
- ⊗ EX. TREE
- ⊠ EX. HYDRANT

- - - PRO. PROJECT LIMITS
- ▒ PRO. ASPHALT
- ▒ PRO. CONCRETE, 7 INCH
- ▒ PRO. CONCRETE, 5 INCH
- ⊕ PRO. TRAFFIC OR PARKING SIGN
- ▒ PRO. ACCESSIBLE STALL PAVEMENT MARKING
- ▒ PRO. TYPE "E" CURB AND GUTTER, REJECT CURB
- ▒ PRO. TYPE "H" CURB AND GUTTER, ACCEPT CURB
- ⊕ PRO. ATHLETIC FIELD LIGHT POLE
- x - PRO. FENCE, PER BID ITEM 90014.

**NOTES**

- CONTRACTOR RESPONSIBLE FOR REPAIRING ANY EXISTING UTILITIES, STRUCTURES, CURB, LAWN, PAVEMENT, ETC. DAMAGED THROUGH CONSTRUCTION ACTIVITIES AT THEIR OWN EXPENSE. REPAIRS MUST BE MADE IN ACCORDANCE WITH THE CITY OF MADISON STANDARD SPECIFICATIONS FOR PUBLIC WORKS CONSTRUCTION.
- CONTRACTOR SHALL NOT STORE ANY MATERIALS OVER MG&E AND ATC EASEMENTS. CONTRACTOR'S SURVEYOR SHALL LOCATE AND STAKE EASEMENTS PRIOR TO CONSTRUCTION.

